

STATE	PROJECT NO.	SHEET NO.	TOTAL SHEETS
N.C.	2025CPT.10.14.20901	1	
F.A. PROJECT NO.			




ENLARGED MUNICIPAL AND SUBURBAN AREAS

# UNION COUNTY

NORTH CAROLINA

PREPARED BY THE

NORTH CAROLINA DEPARTMENT OF TRANSPORTATION  
DIVISION OF HIGHWAYS - DIVISION 10 DISTRICT 3

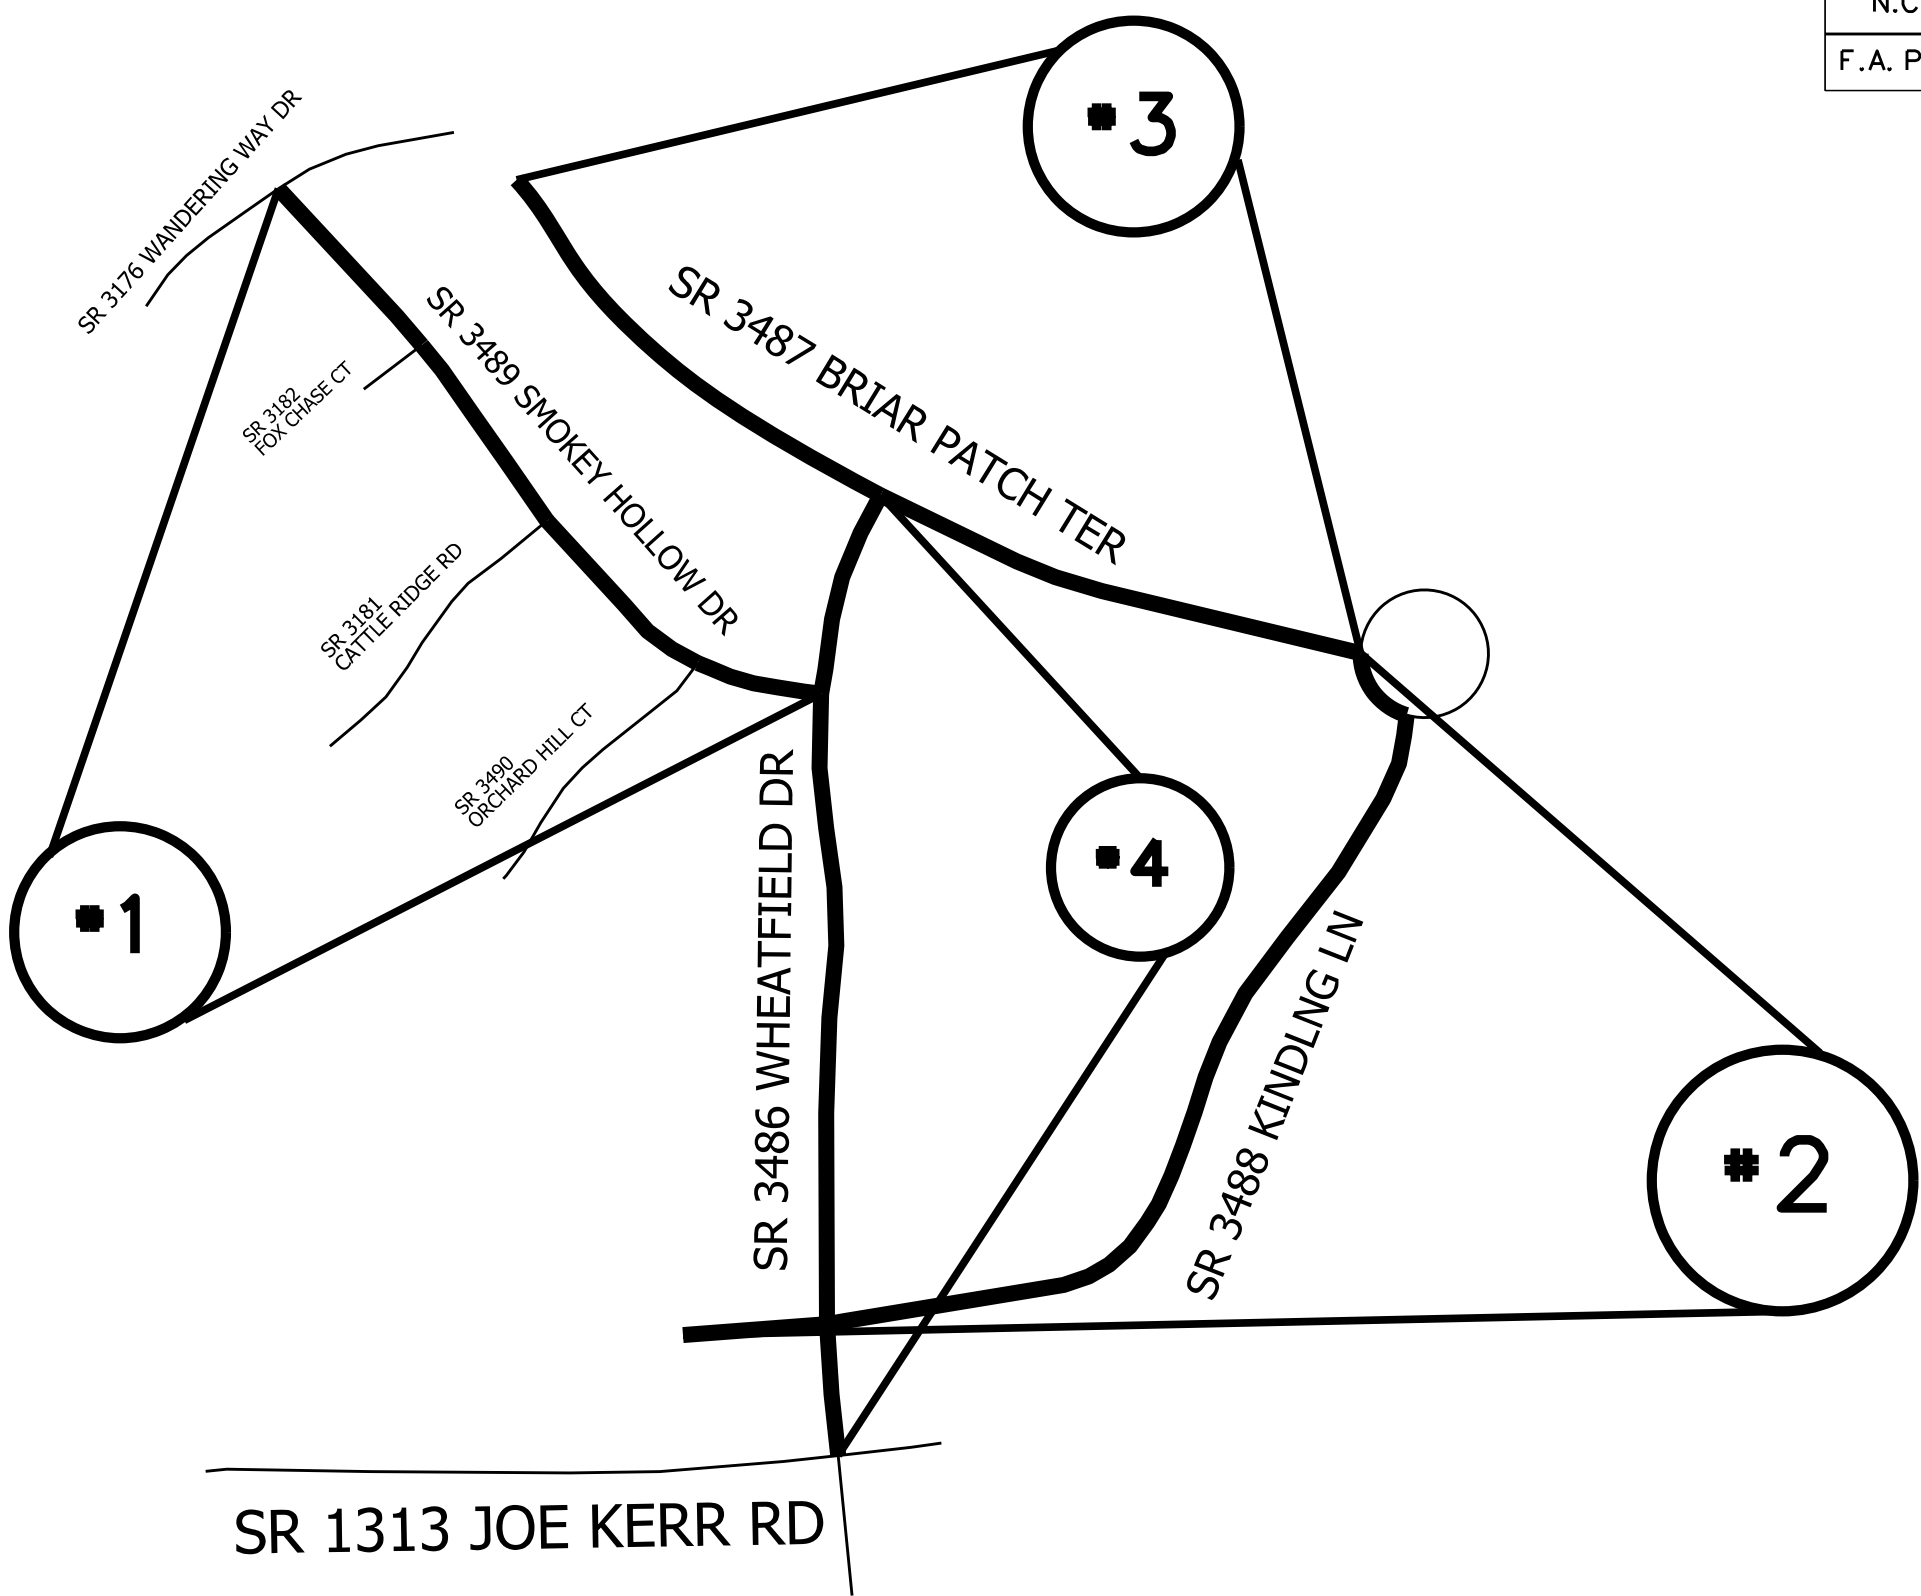

MAP #1 SR 3489 SMOKEY HOLLOW DR  
.30 MILES  
FROM SR 3486 WHEATFIELD DR  
TO SR 3176 WANDERING WAY

MAP #2 SR 3488 KINDLING WOOD LN  
.43 MILES  
FROM SR 3487 BRIAR PATCH TERRACE  
TO END OF MAINTENANCE

MAP #3 SR 3487 BRIAR PATCH TERRACE  
.40 MILES  
FROM SR 3488 KINDLING WOOD LN  
TO END OF MAINTENANCE

MAP #4 SR 3486 WHEATFIELD DR  
.38 MILES  
FROM SR 1313 JOE KERR RD  
TO SR 3487 BRIAR PATCH TERRACE

STATE	PROJECT NO.	SHEET NO.	TOTAL SHEETS
N.C.	2025CPT.10.14.20901	2	
F.A. PROJECT NO.			




ENLARGED MUNICIPAL AND SUBURBAN AREAS

UNION COUNTY

NORTH CAROLINA

PREPARED BY THE  
NORTH CAROLINA DEPARTMENT OF TRANSPORTATION  
DIVISION OF HIGHWAYS - DIVISION 10 DISTRICT 3

MAP #5 SR 3177 GROVES EDGE LN  
.56 MILES  
FROM SR 2948 MARVIN SCHOOL RD  
TO SR 3816 RUNNING HORSE LN

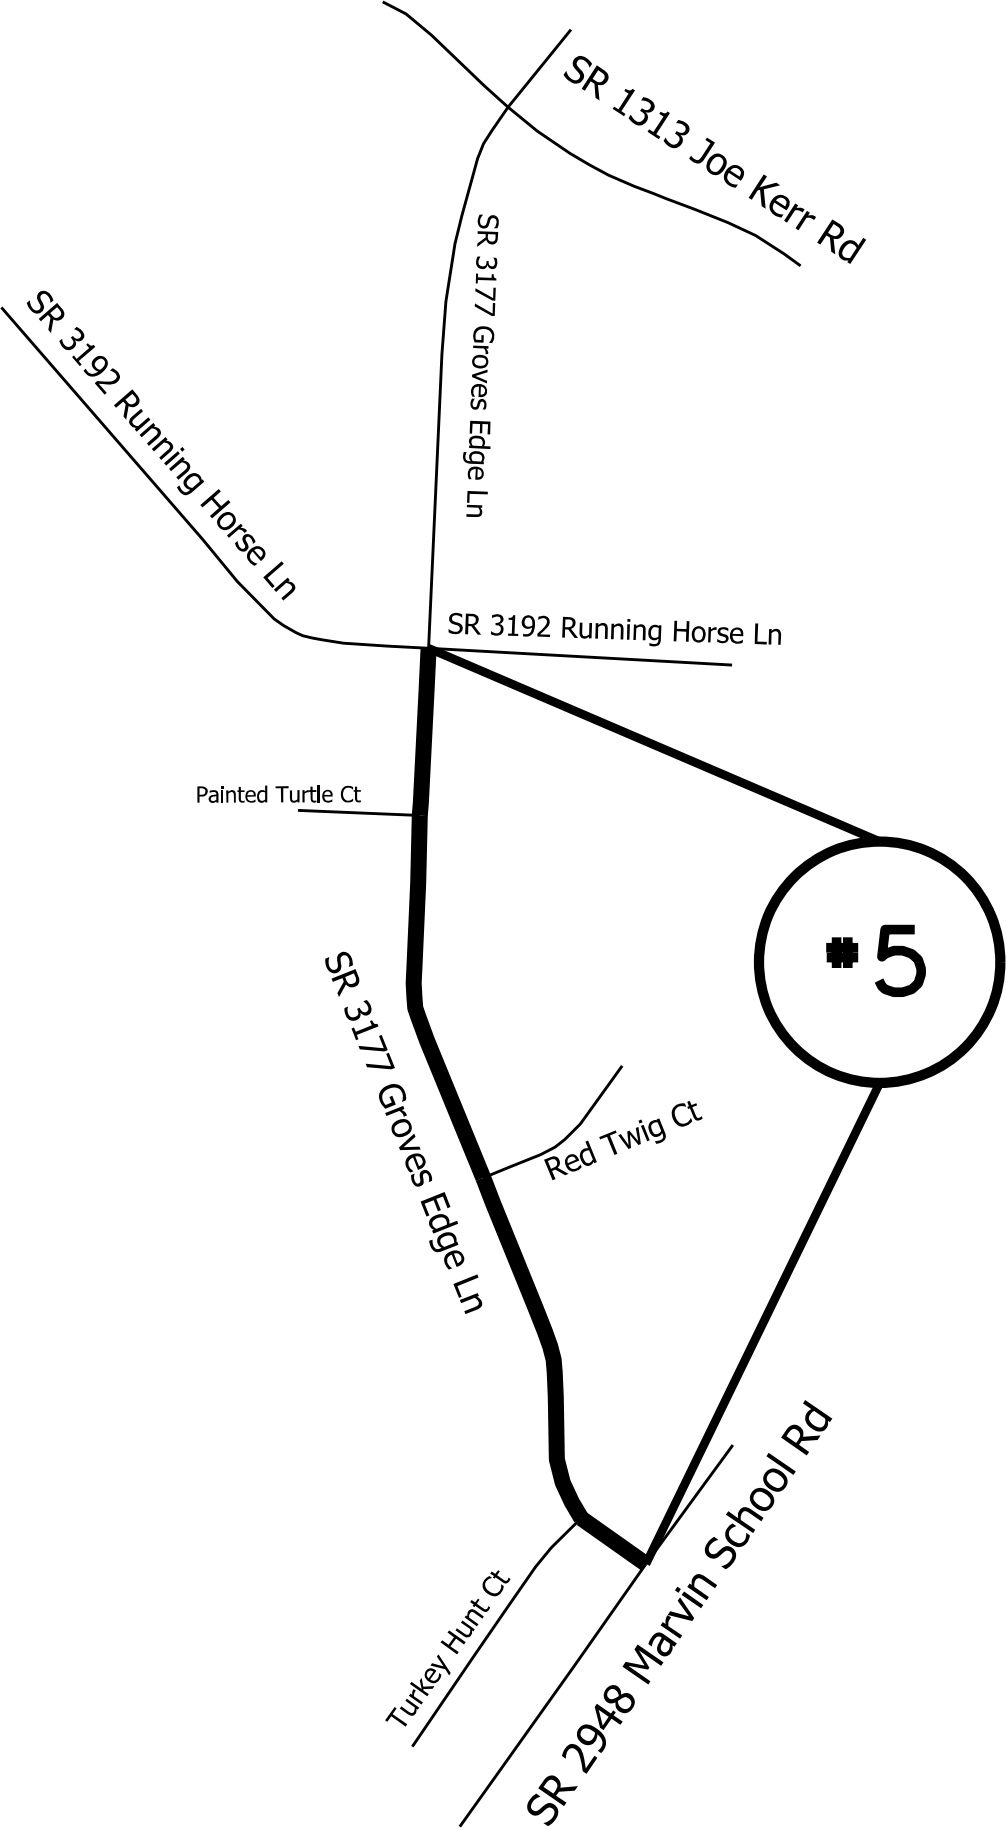

STATE	PROJECT NO.	SHEET NO.	TOTAL SHEETS
N.C.	2025CPT.10.14.20901	3	
F.A. PROJECT NO.			



ENLARGED MUNICIPAL AND SUBURBAN AREAS

UNION COUNTY


NORTH CAROLINA

PREPARED BY THE

NORTH CAROLINA DEPARTMENT OF TRANSPORTATION  
DIVISION OF HIGHWAYS - DIVISION 10 DISTRICT 3

MAP #6 SR 3331 SILK POND DR  
.13 MILES  
FROM SR 3328 AVANTI DR  
TO END OF MAINTENANCE

MAP #11 SR 3328 AVANTI DR  
.66 MILES  
FROM NC 16  
TO END OF MAINTENANCE

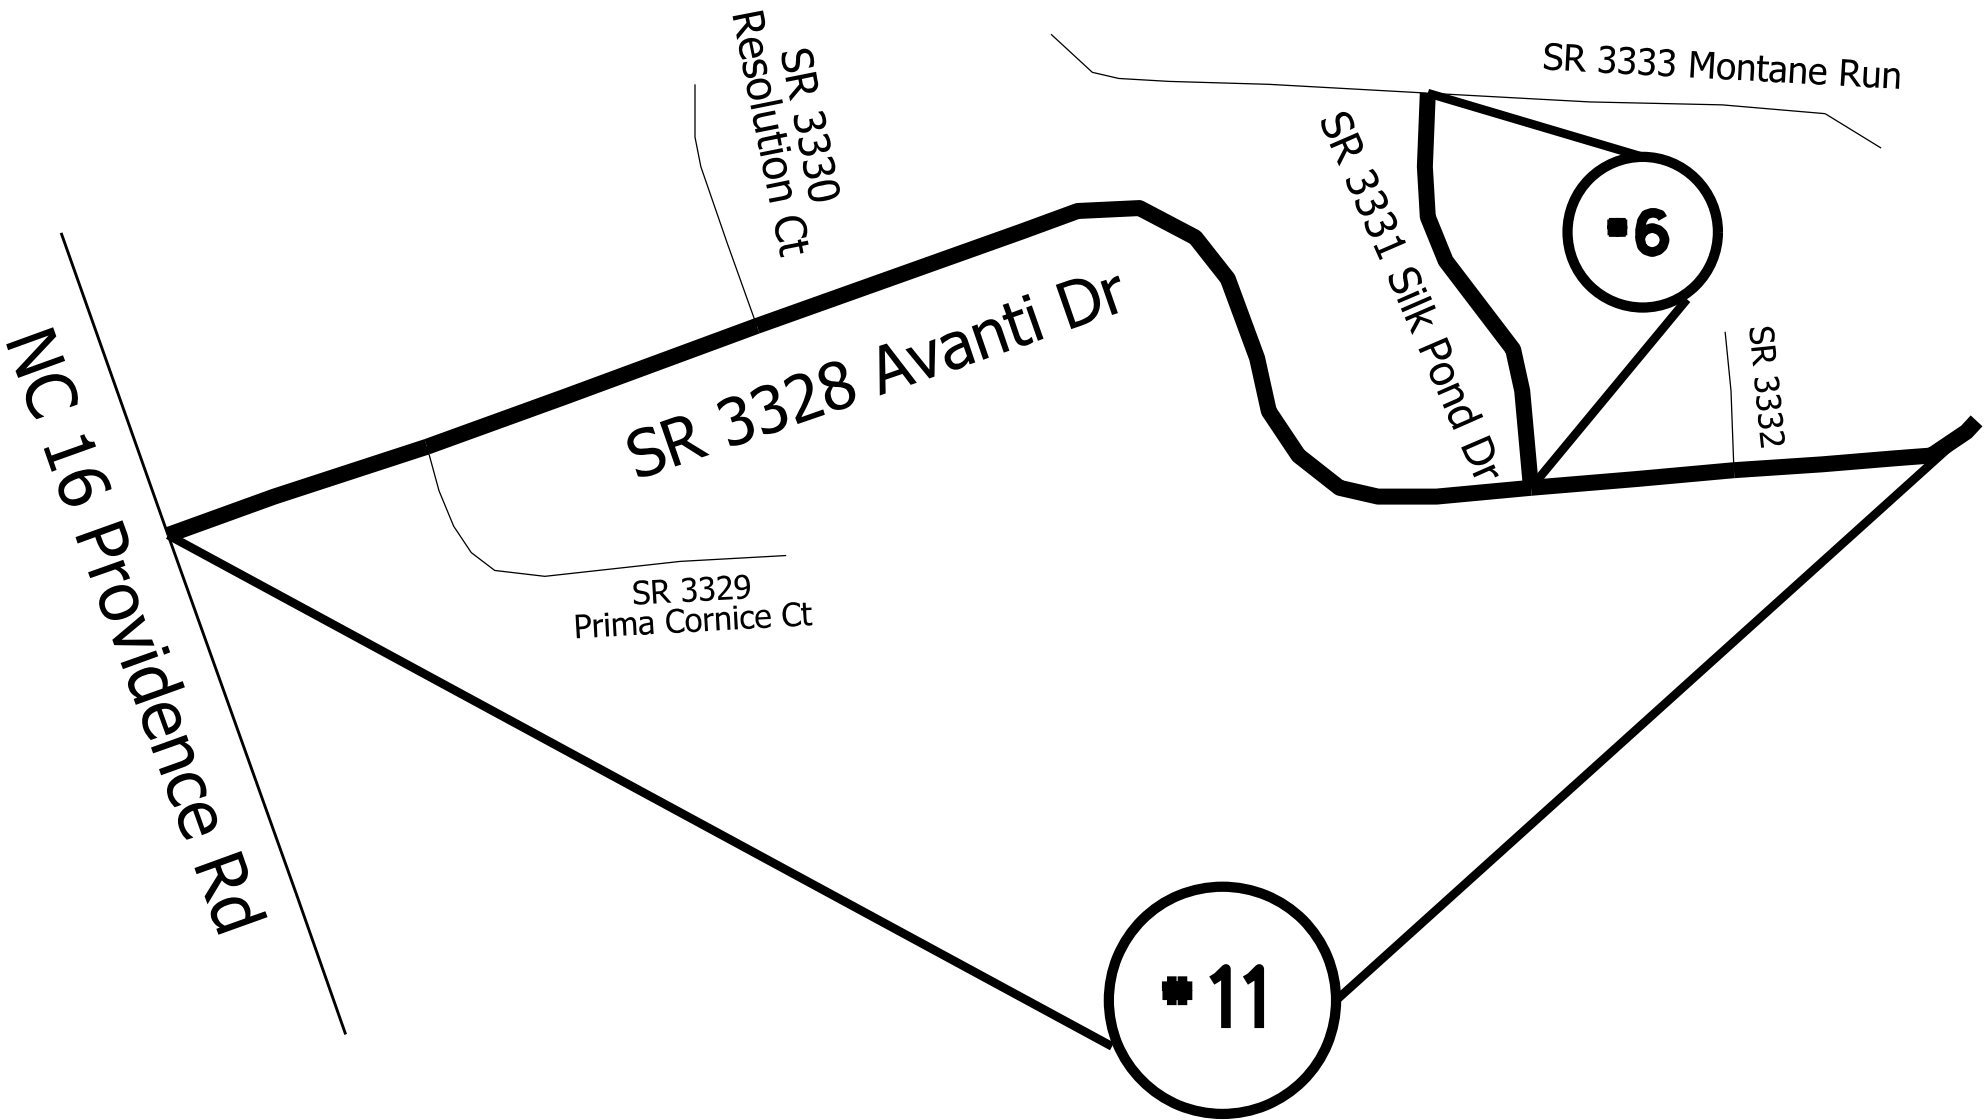

STATE	PROJECT NO.	SHEET NO.	TOTAL SHEETS
N.C.	2025CPT.10.14.20901	4	
F.A. PROJECT NO.			



ENLARGED MUNICIPAL AND SUBURBAN AREAS

# UNION COUNTY

## NORTH CAROLINA


PREPARED BY THE  
NORTH CAROLINA DEPARTMENT OF TRANSPORTATION  
DIVISION OF HIGHWAYS - DIVISION 10 DISTRICT 3

MAP #7 SR 3332 PTARMIGAN CT  
.04 MILES  
FROM SR 3328 AVANTI DR  
TO END OF MAINTENANCE

MAP #8 SR 3333 MONTANE RUN CT  
.26 MILES  
FROM END ON MAINTENANCE  
TO END OF MAINTENANCE

MAP #9 SR 3330 RESOLUTION CT  
.08 MILES  
FROM END OF MAINTENANCE  
TO END OF MAINTENANCE

MAP #10 SR 3329 PRIMA CORNICE CT  
.15 MILES  
FROM SR 3328 AVANTI DR  
TO END OF MAINTENANCE

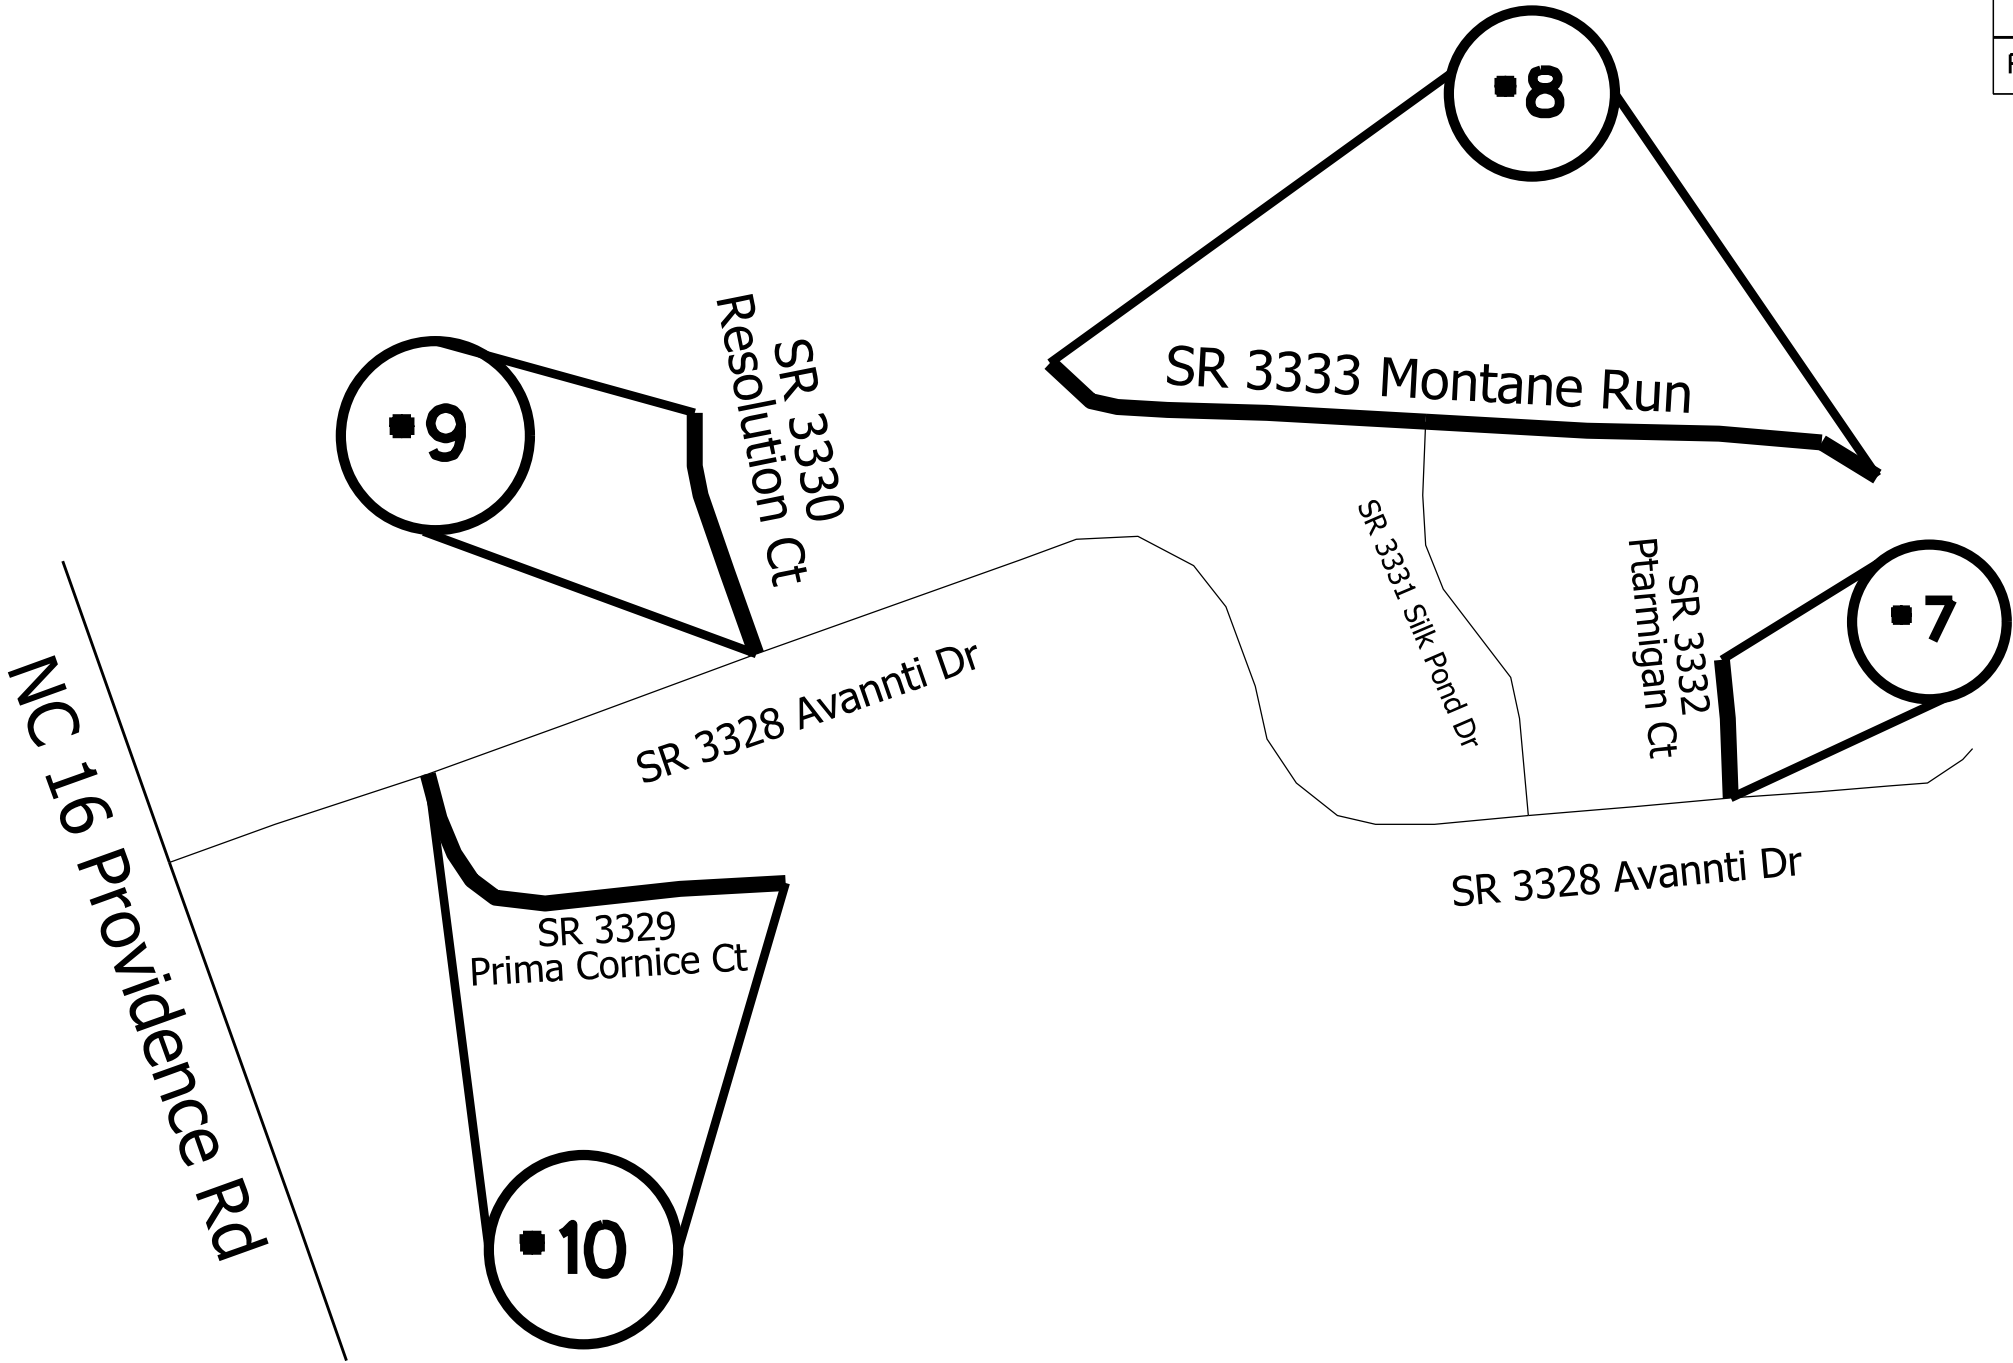

STATE	PROJECT NO.	SHEET NO.	TOTAL SHEETS
N.C.	2025CPT.10.14.20901	5	
F.A. PROJECT NO.			



ENLARGED MUNICIPAL AND SUBURBAN AREAS

# UNION COUNTY

NORTH CAROLINA

PREPARED BY THE  
NORTH CAROLINA DEPARTMENT OF TRANSPORTATION  
DIVISION OF HIGHWAYS - DIVISION 10 DISTRICT 3


MAP #12 SR 3838 PELHAM LN  
.04 MILES  
FROM SR 3641 APPOMATOX DR  
TO END OF MAINTENANCE

MAP #13 SR 3839 BRISTOL CT  
.04 MILES  
FROM SR 3641 APPOMATOX DR  
TO END OF MAINTENANCE


MAP #15 SR 3642 ARMISTEAD CT  
.07 MILES  
FROM SR 3640 WYNDHAM LN  
TO END OF MAINTENANCE

MAP #16 SR 3840 CORBIN CT  
.03 MILES  
FROM SR 3641 APPOMATOX DR  
TO END OF MAINTENANCE

MAP #18 SR 3841 MARVIN BRANCH CT  
.05 MILES  
FROM SR 3643 STONEHURST LN  
TO END OF MAINTENANCE

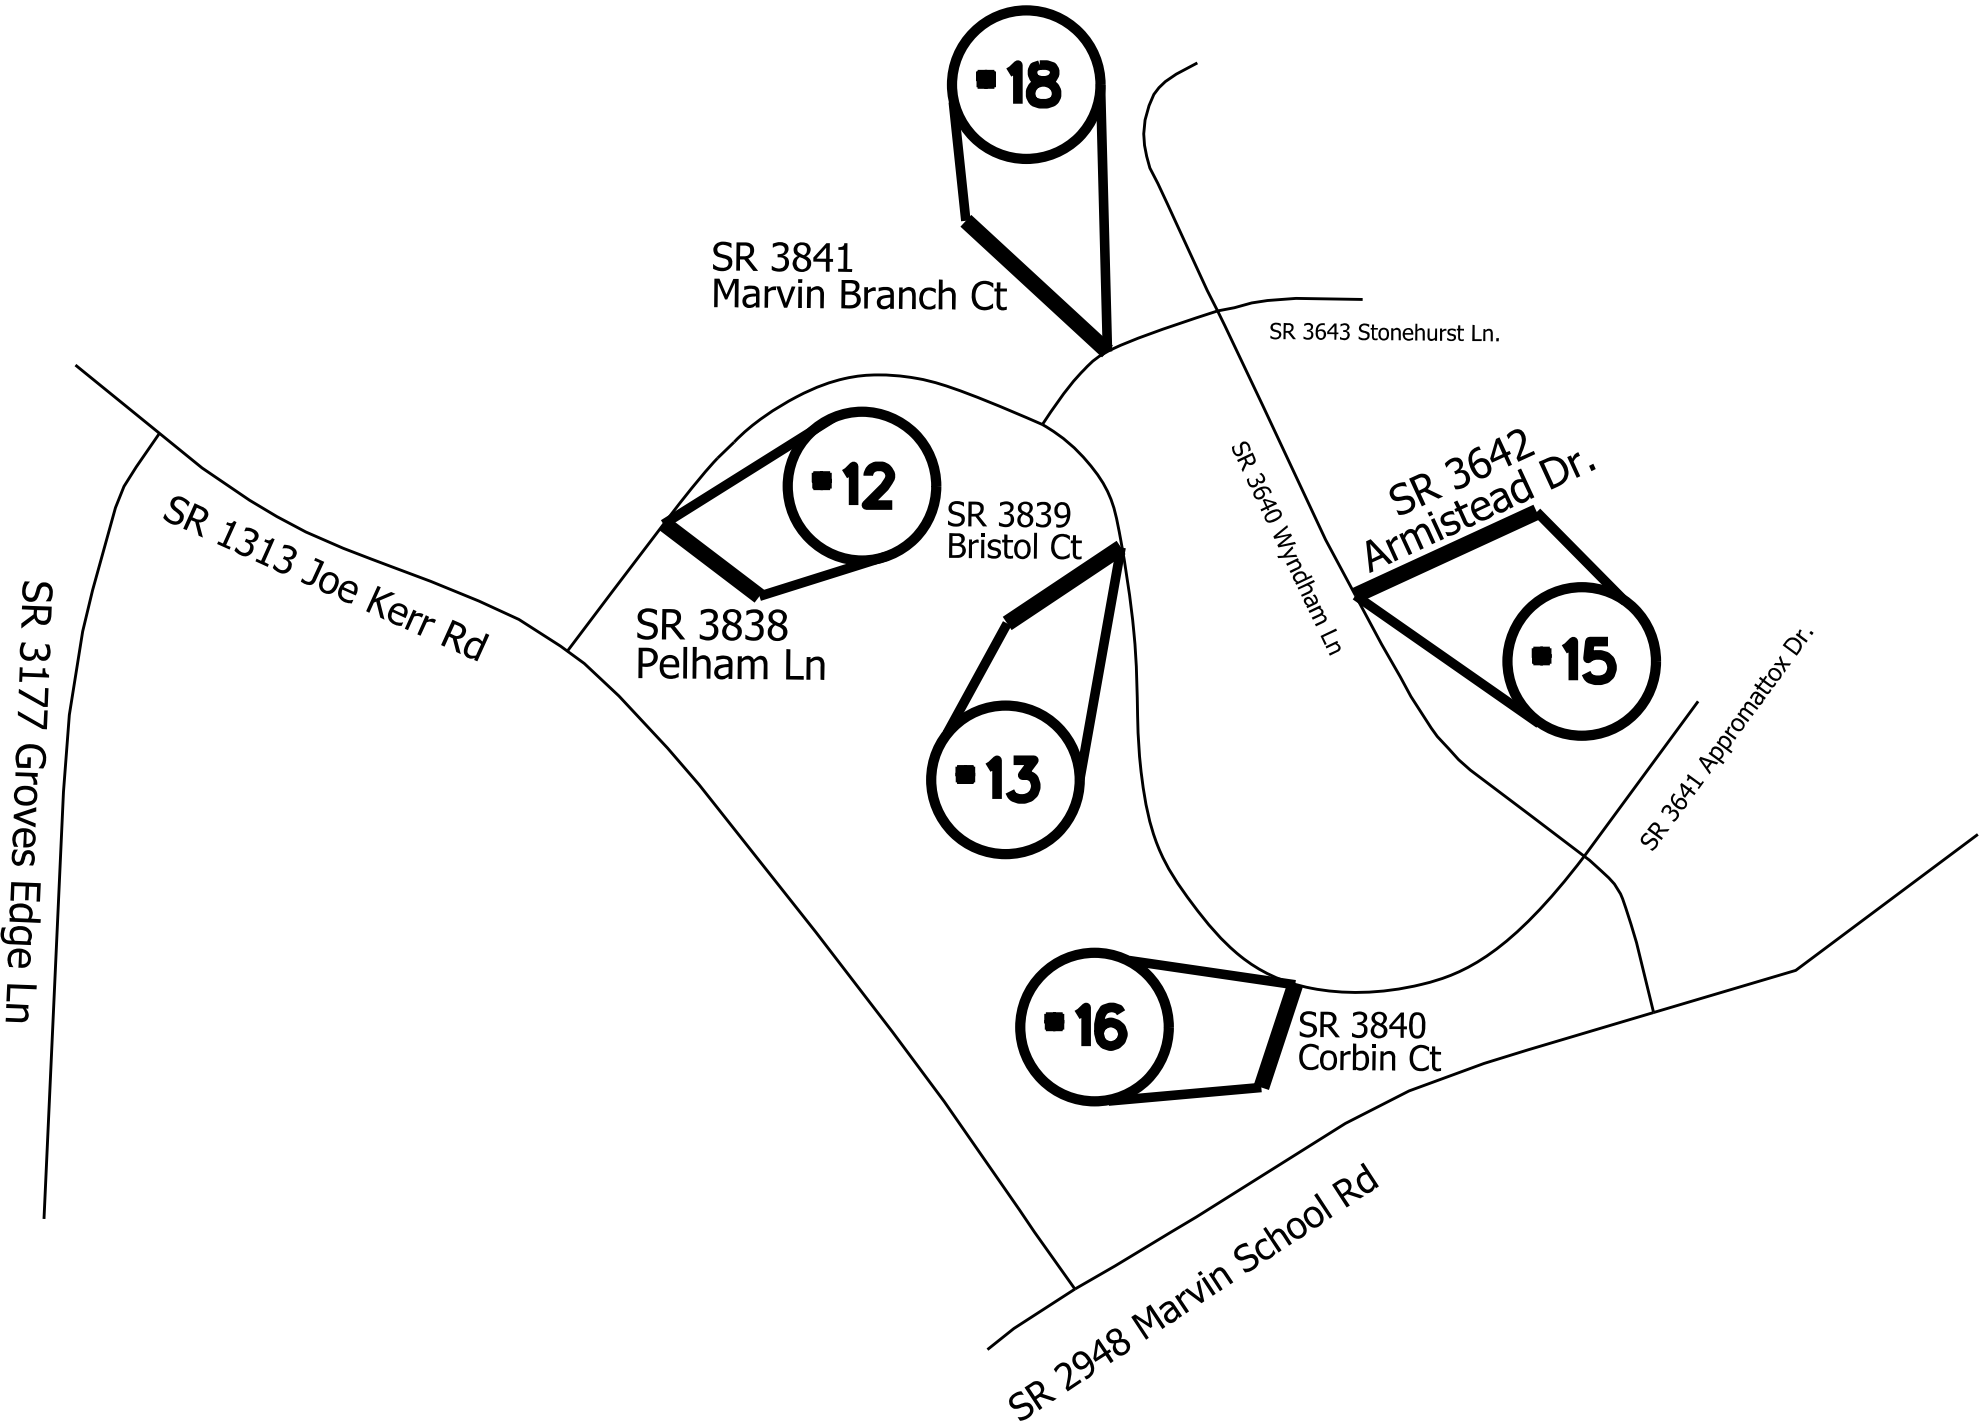

STATE	PROJECT NO.	SHEET NO.	TOTAL SHEETS
N.C.	2025CPT.10.14.20901	6	
F.A. PROJECT NO.			

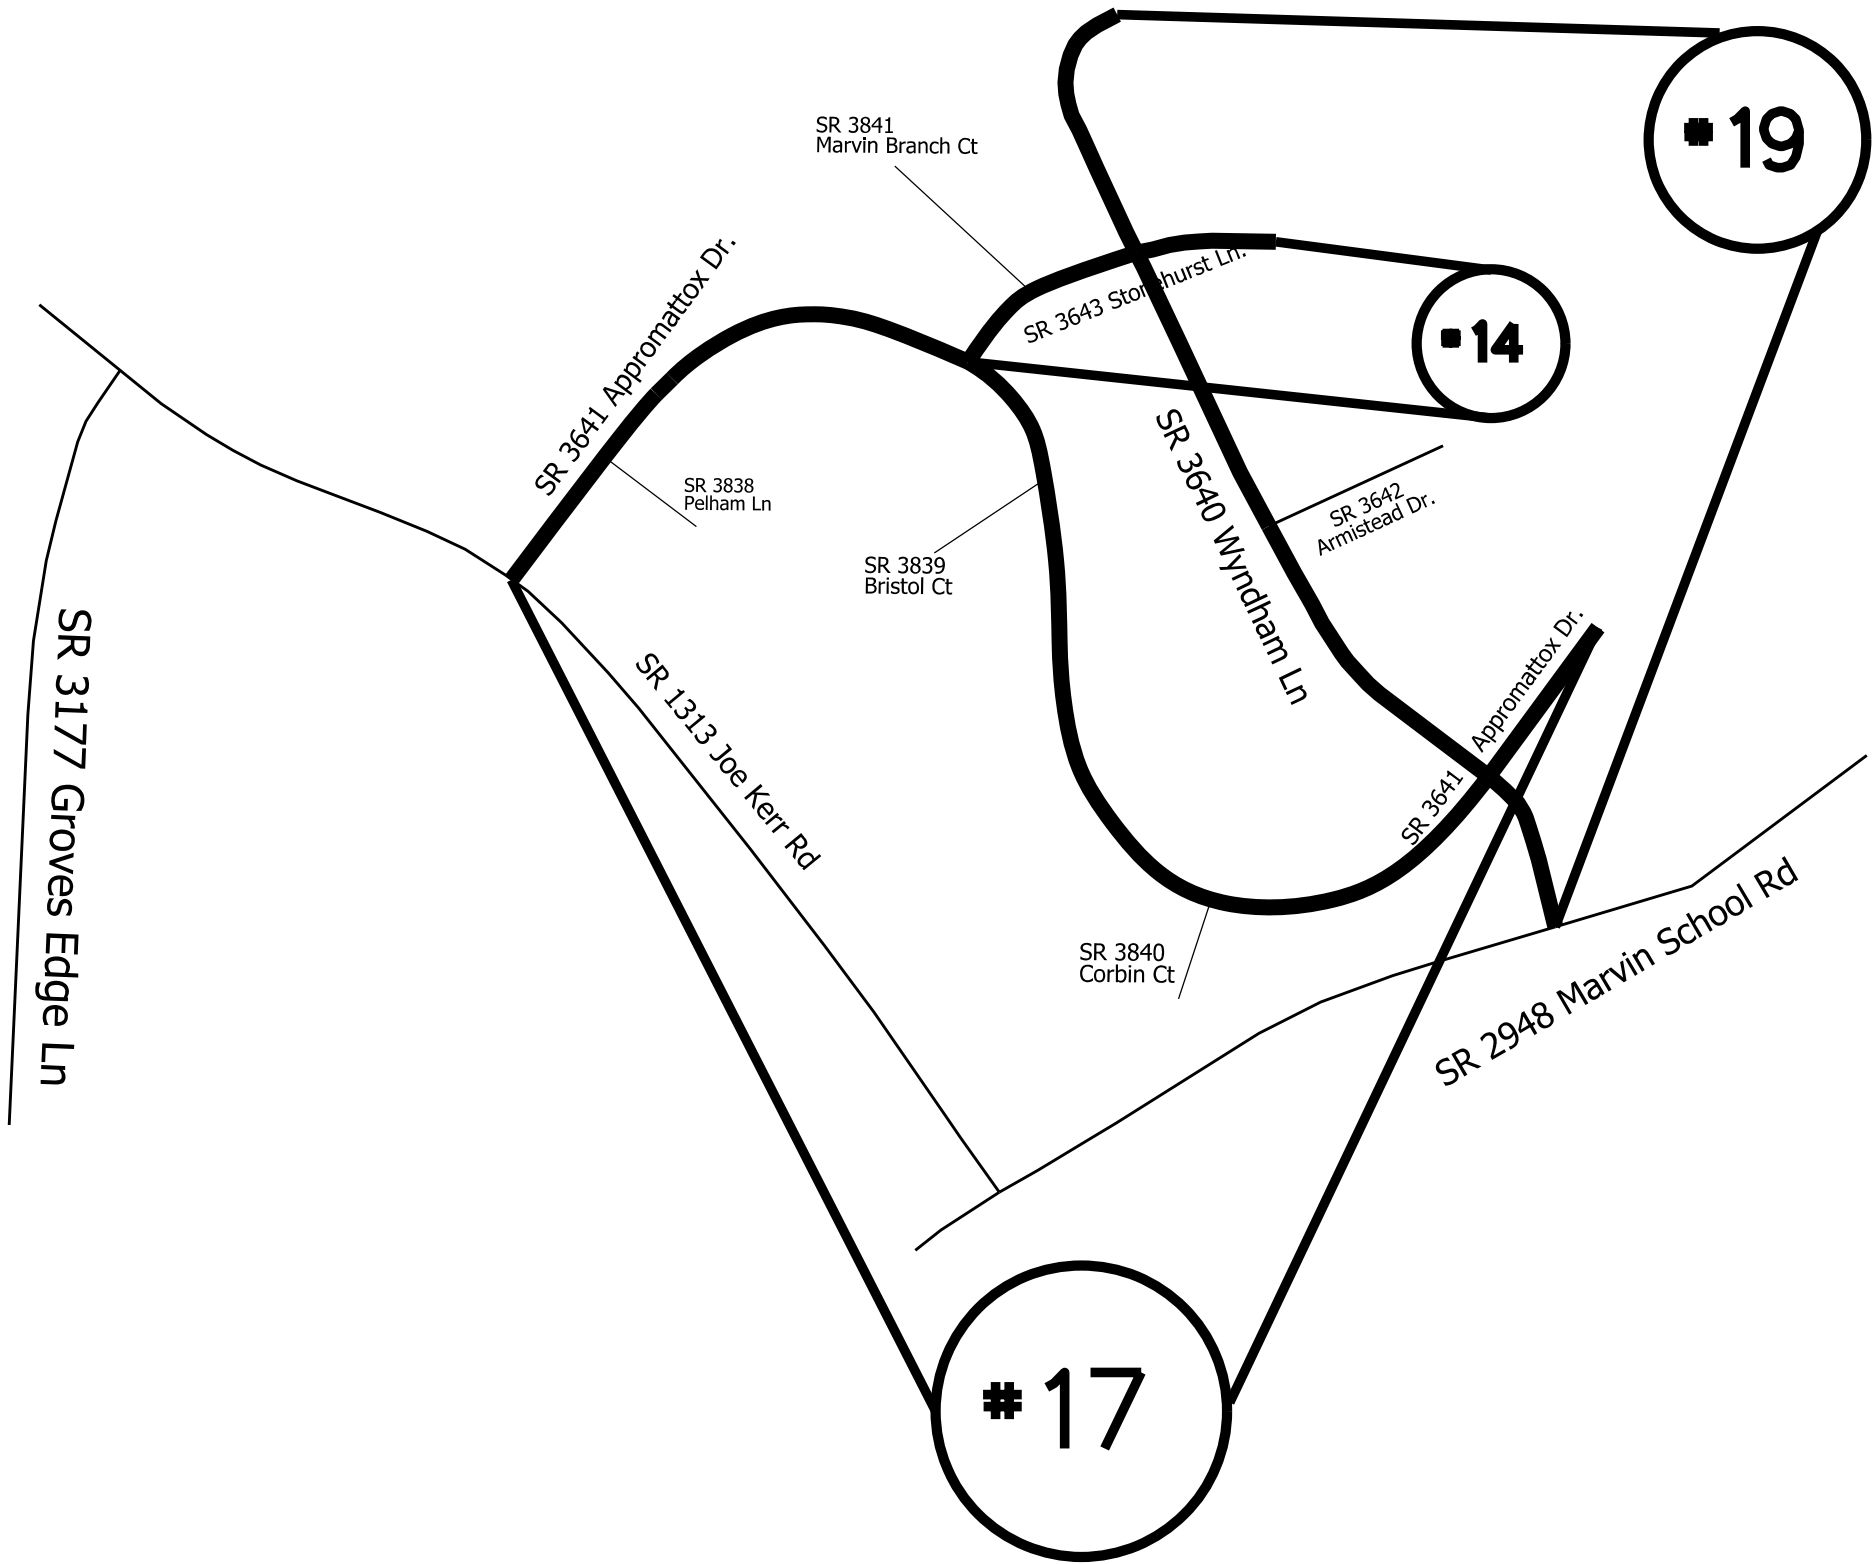


ENLARGED MUNICIPAL AND SUBURBAN AREAS  
UNION COUNTY  
NORTH CAROLINA  
PREPARED BY THE  
NORTH CAROLINA DEPARTMENT OF TRANSPORTATION  
DIVISION OF HIGHWAYS - DIVISION 10 DISTRICT 3

MAP #14 SR 3643 STONEHURST LN  
.18 MILES  
FROM SR 3641 APPOMATTOX DR  
TO END OF MAINTENANCE

MAP #17 SR 3641 APPOMATTOX DR  
.62 MILES  
FROM SR 1313 JOE KERR RD  
TO END OF MAINTENANCE

MAP #19 SR 3640 WYNDHAM LN  
.44 MILES  
FROM SR 2948 MARVIN SCHOOL RD  
TO END OF MAINTENANCE

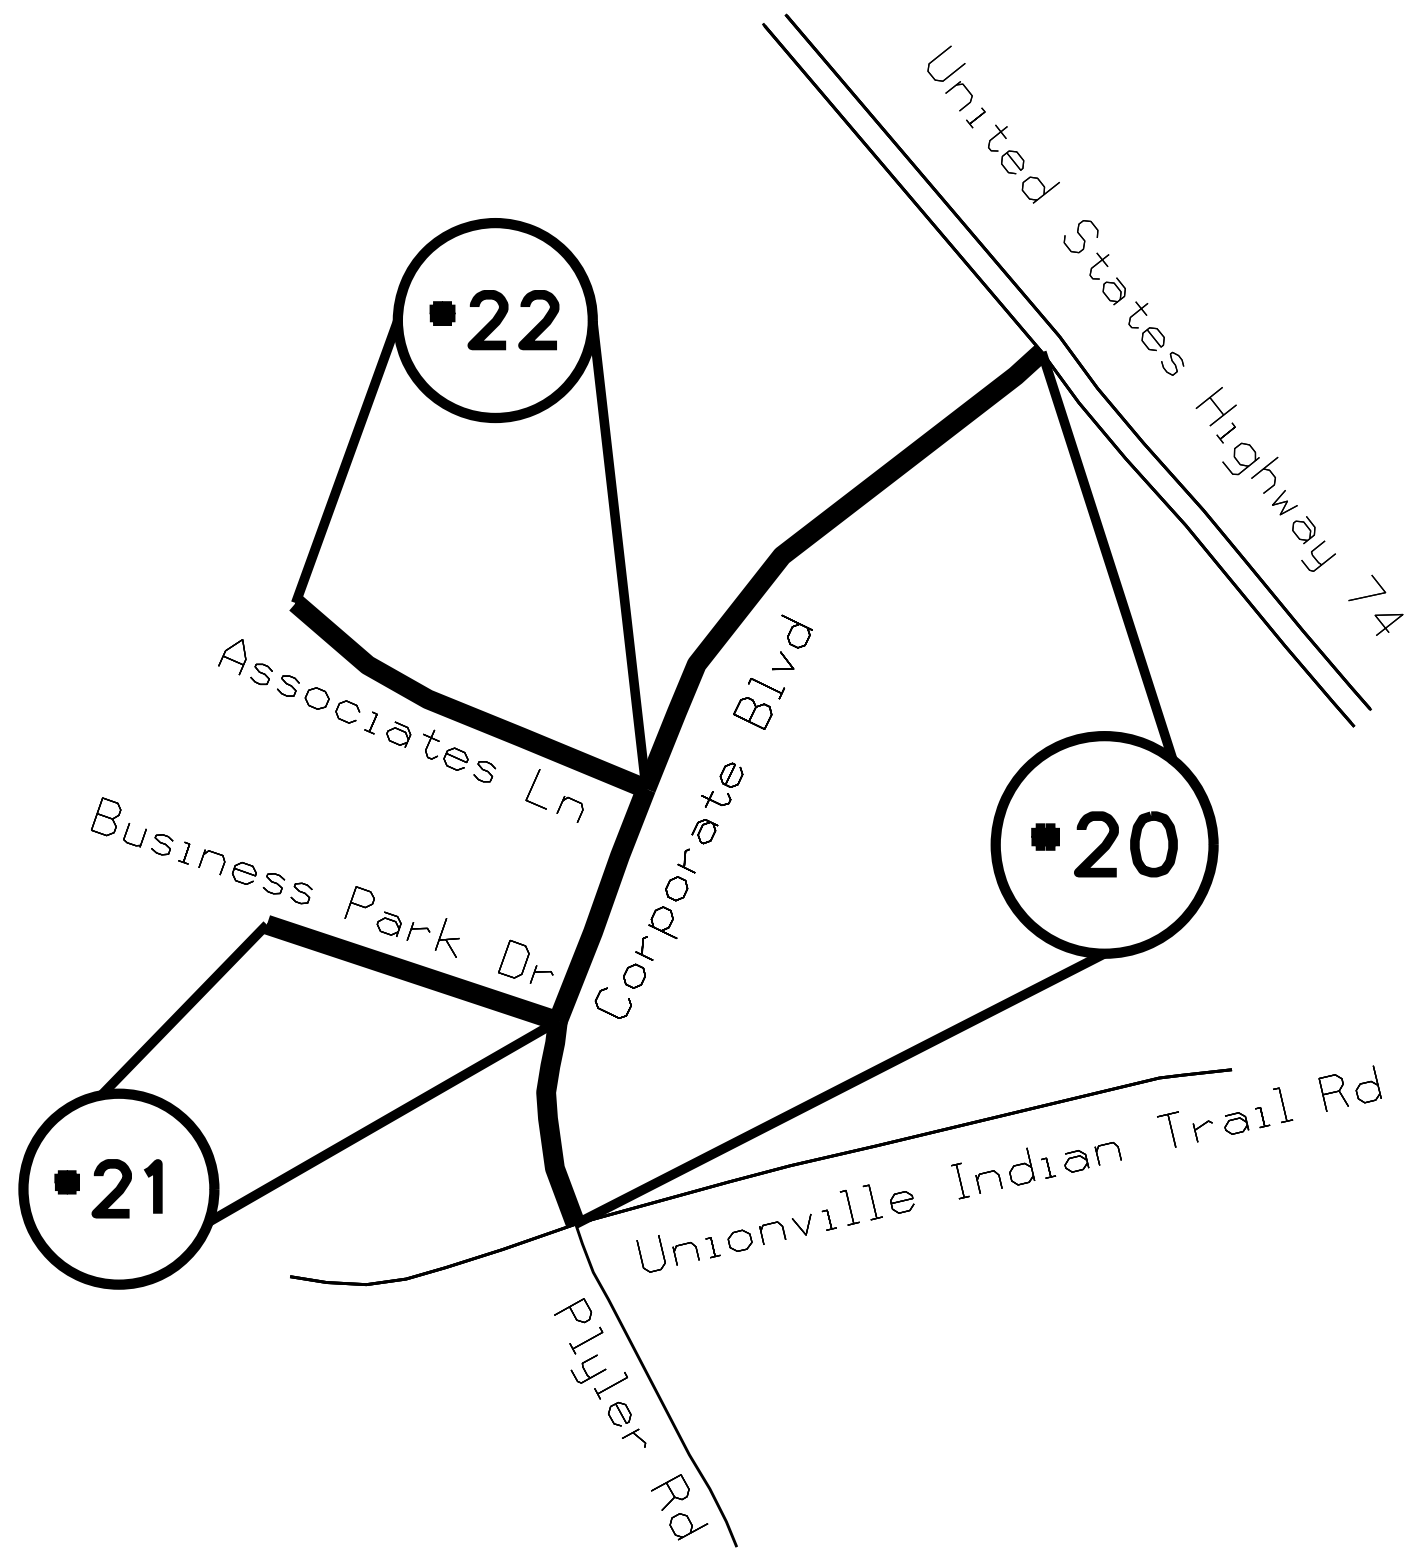

STATE	PROJECT NO.	SHEET NO.	TOTAL SHEETS
N.C.	2025CPT.10.14.20901	7	
F.A. PROJECT NO.			



ENLARGED MUNICIPAL AND SUBURBAN AREAS

UNION COUNTY

NORTH CAROLINA

PREPARED BY THE


NORTH CAROLINA DEPARTMENT OF TRANSPORTATION  
DIVISION OF HIGHWAYS - DIVISION 10 DISTRICT 3

MAP #20 SR 2649 CORPORATE BLVD  
.38 MILES  
FROM US 74  
TO SR 1367 UNIONVILLE INDIAN TRAIL RD

MAP #21 SR 2650 BUSINESS PARD DR  
.13 MILES  
FROM SR 2649 CORPORATE BLVD  
TO END OF MAINTENANCE

MAP #22 SR 2651 ASSOCIATES DR  
.10 MILES  
FROM SR 2649 CORPORATE BLVD  
TO END OF MAINTENANCE


STATE	PROJECT NO.	SHEET NO.	TOTAL SHEETS
N.C.	2025CPT.10.14.20901	8	
F.A. PROJECT NO.			

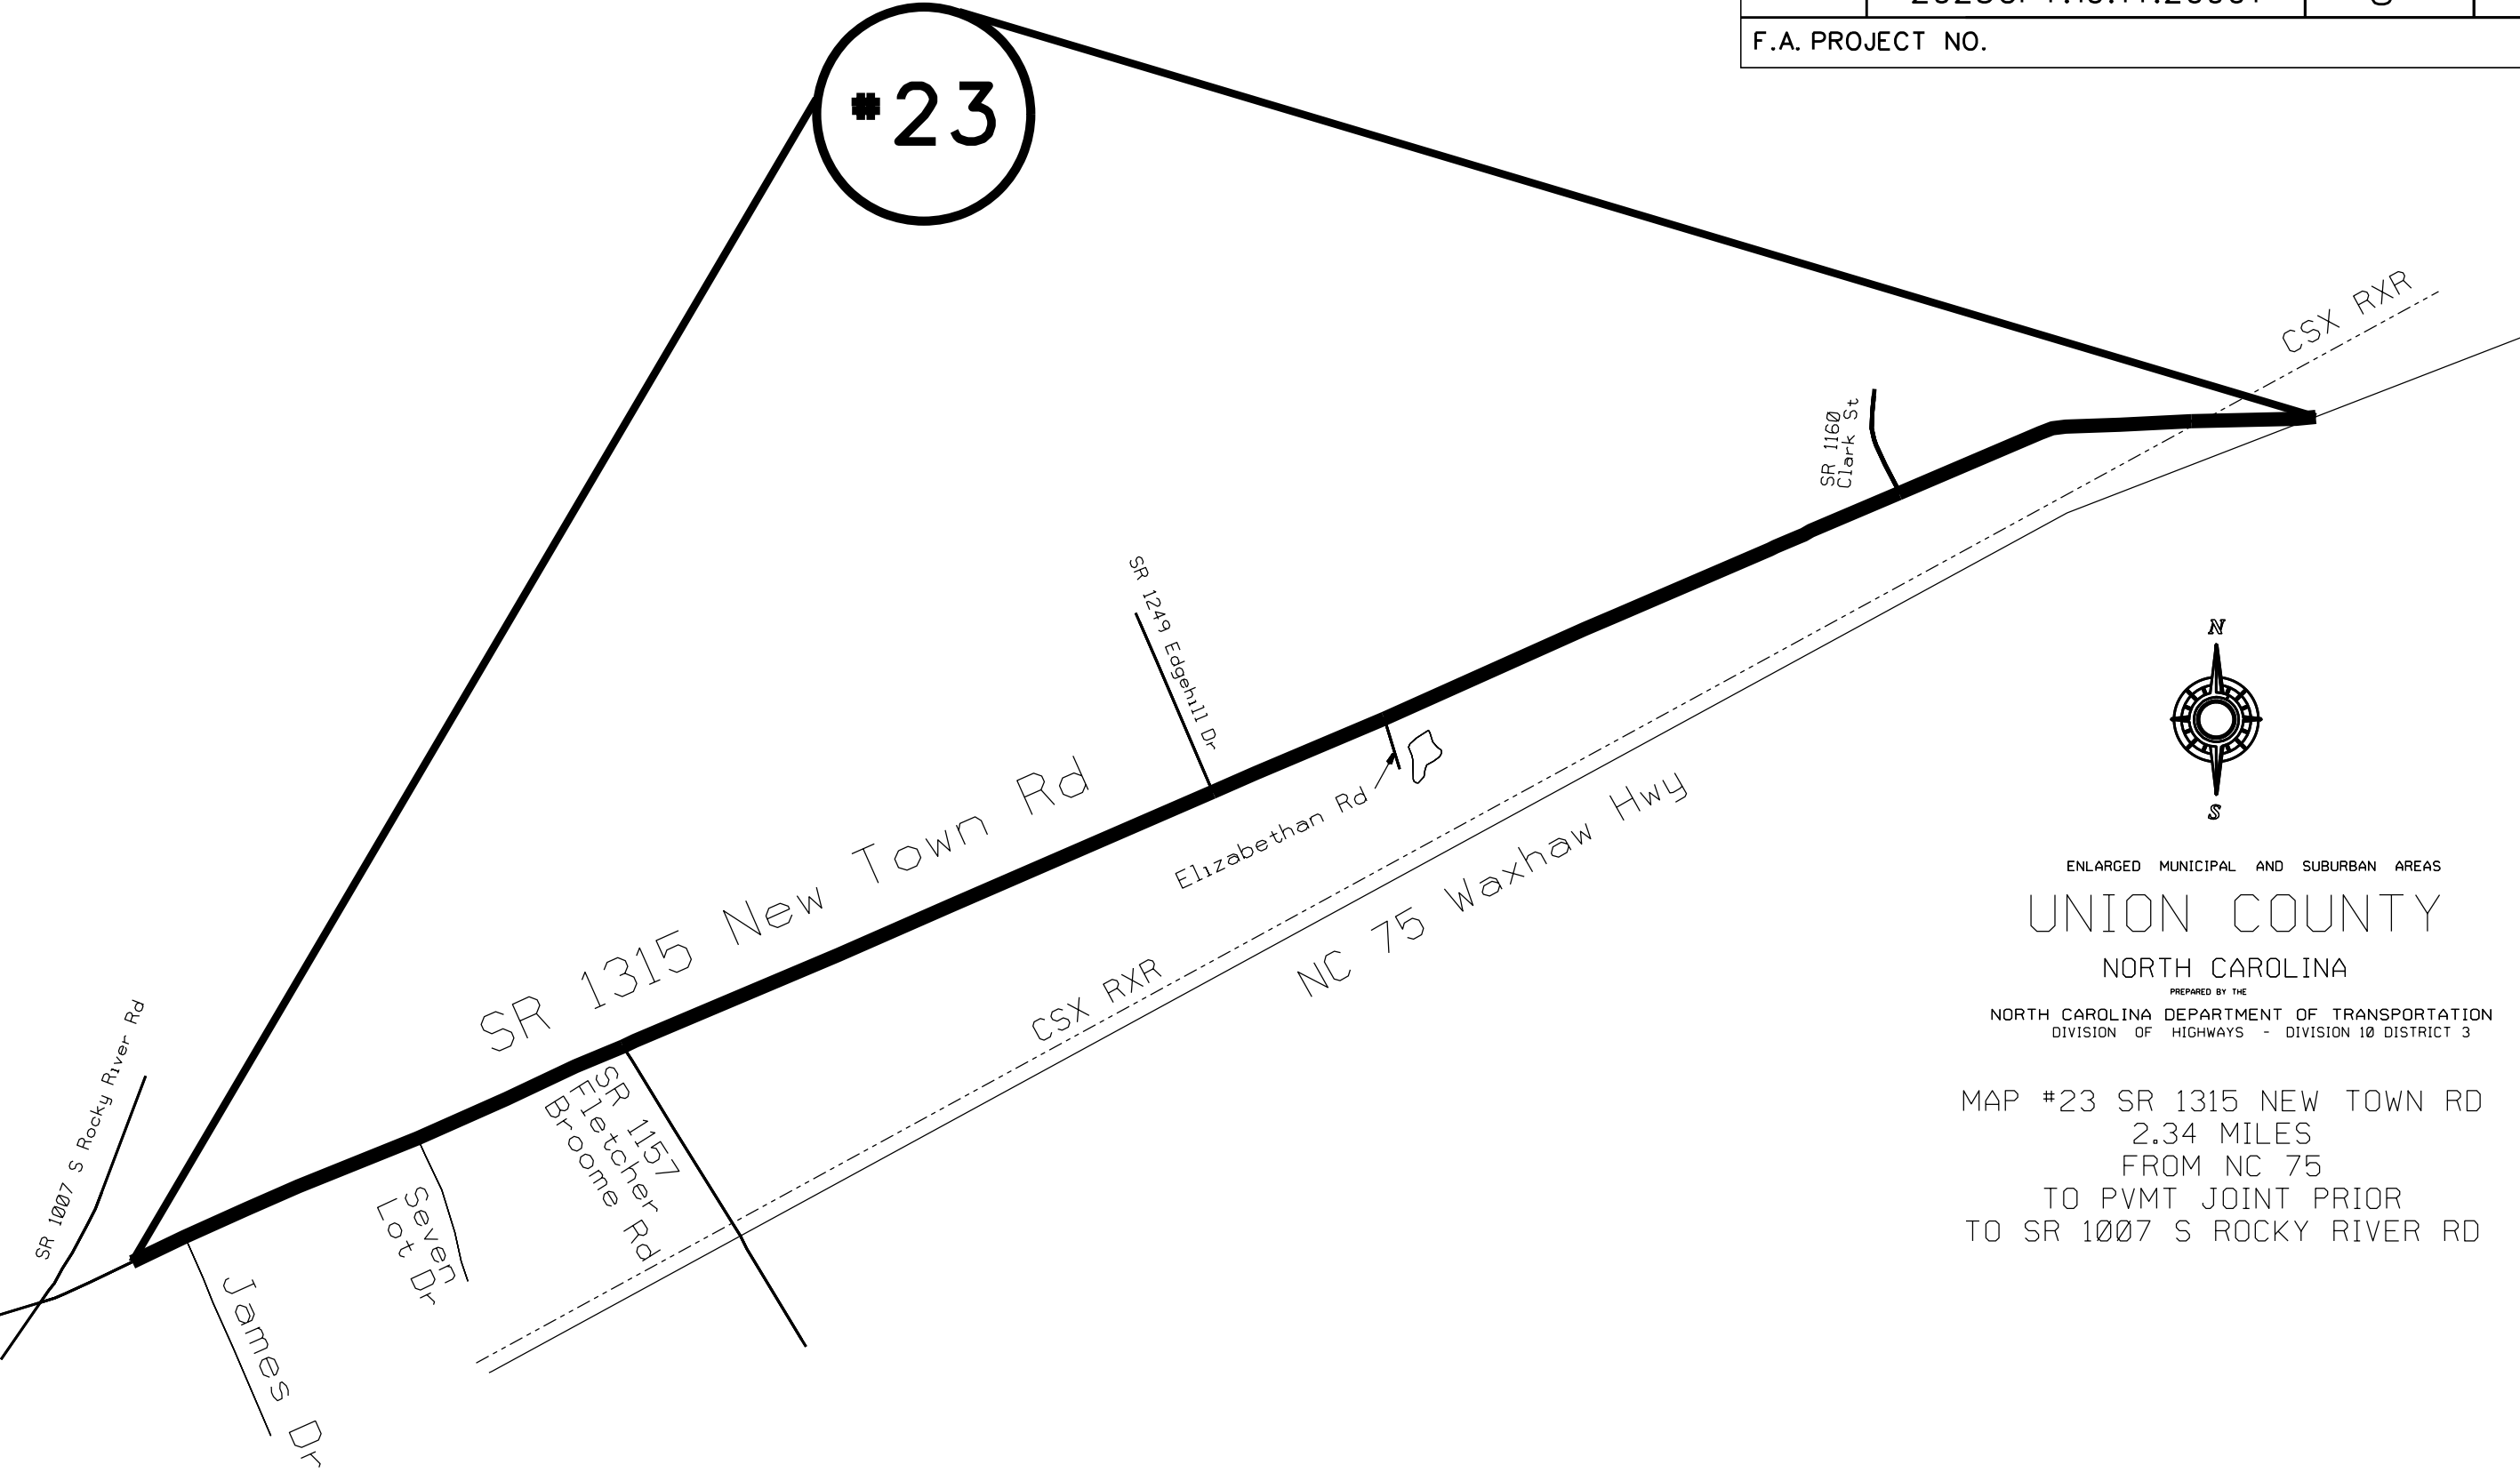

ENLARGED MUNICIPAL AND SUBURBAN AREAS  
UNION COUNTY  
NORTH CAROLINA  
PREPARED BY THE  
NORTH CAROLINA DEPARTMENT OF TRANSPORTATION  
DIVISION OF HIGHWAYS - DIVISION 10 DISTRICT 3

MAP #23 SR 1315 NEW TOWN RD  
2.34 MILES  
FROM NC 75  
TO PVMT JOINT PRIOR  
TO SR 1007 S ROCKY RIVER RD



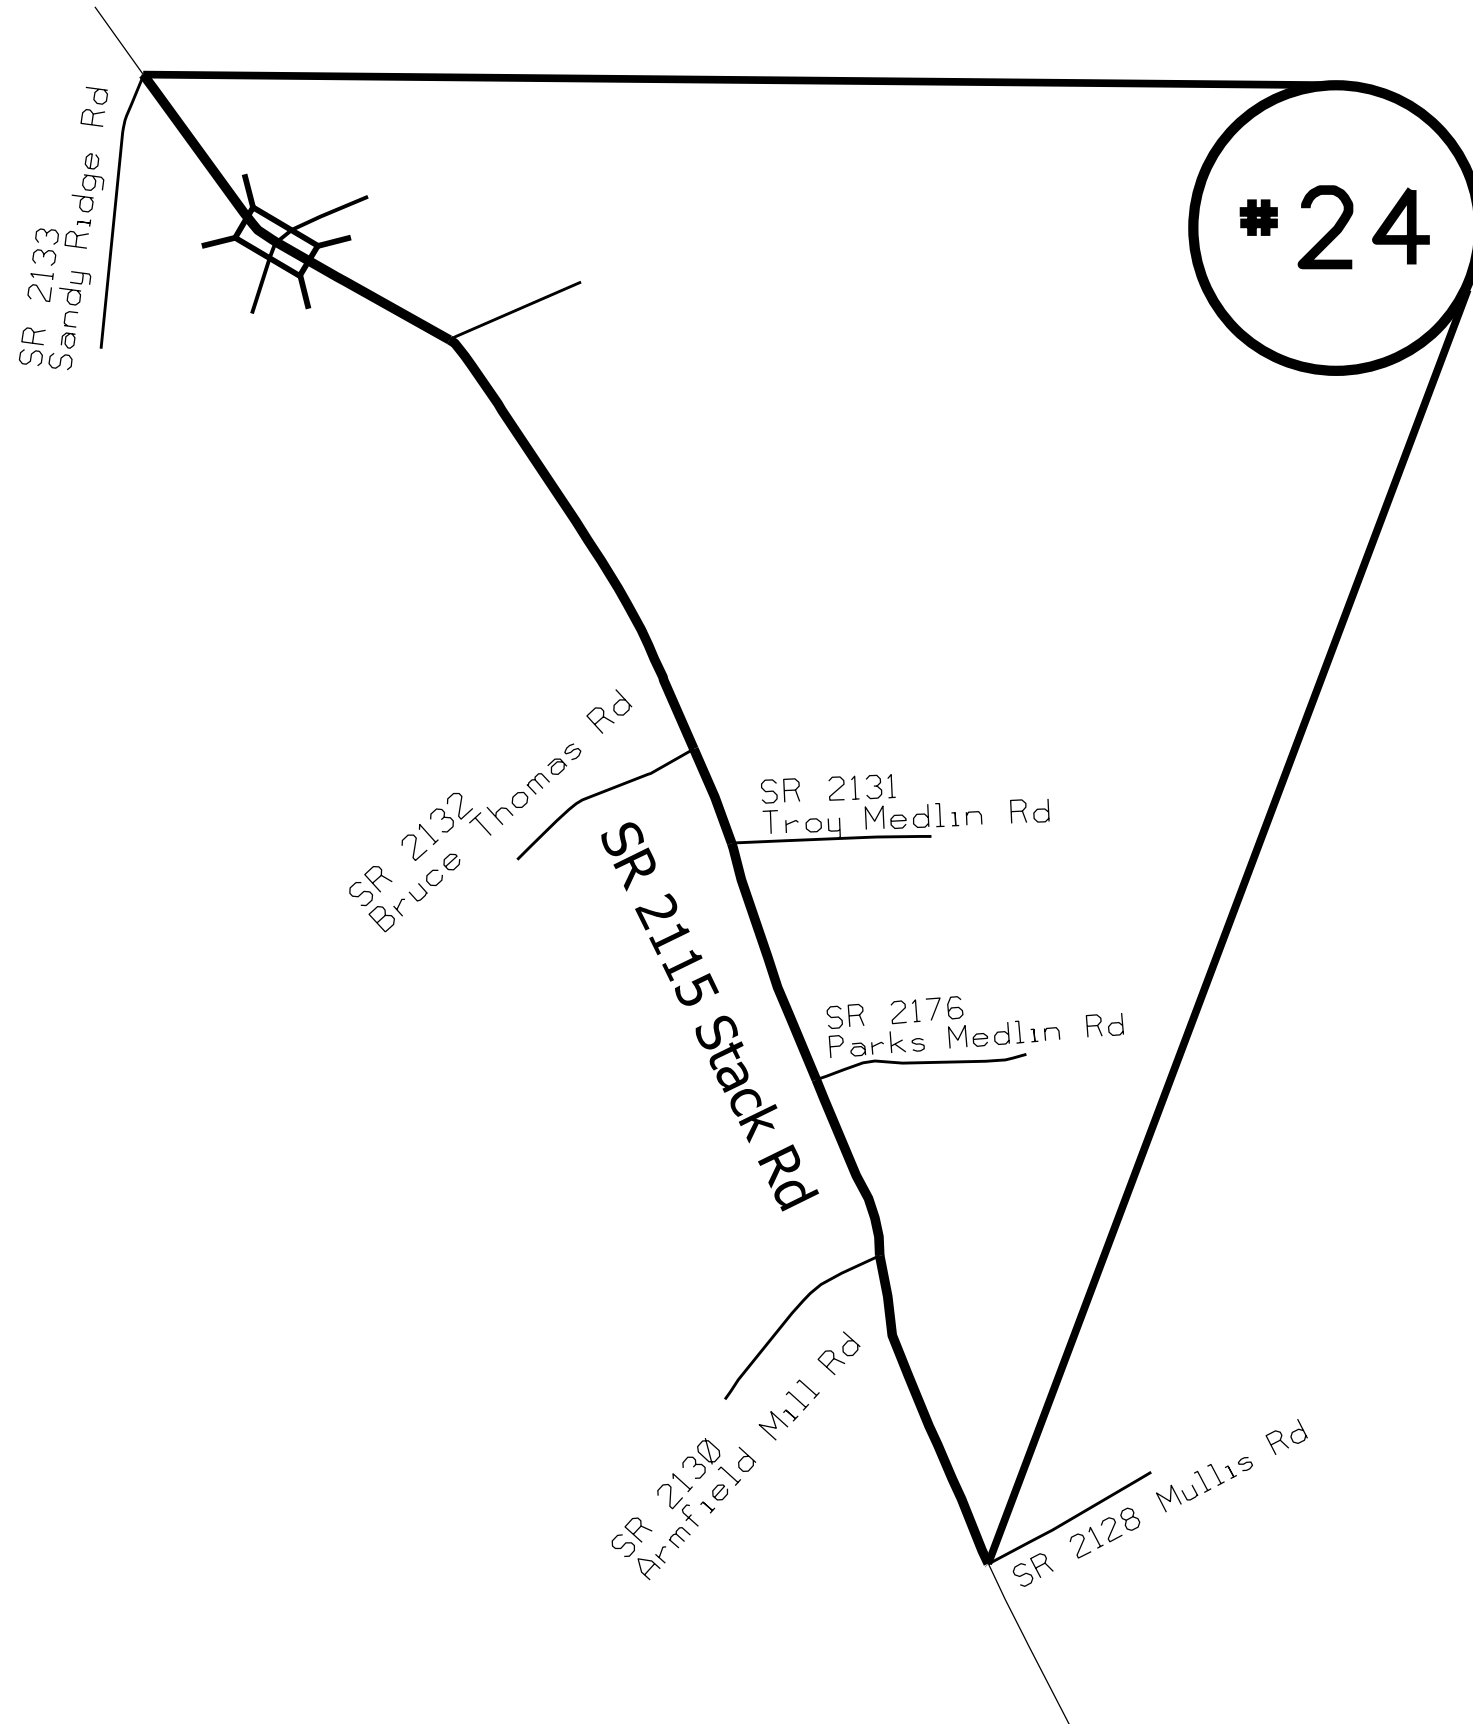

STATE	PROJECT NO.	SHEET NO.	TOTAL SHEETS
N.C.	2025CPT.10.14.20901	9	
F.A. PROJECT NO.			



ENLARGED MUNICIPAL AND SUBURBAN AREAS

UNION COUNTY

NORTH CAROLINA

PREPARED BY THE  
NORTH CAROLINA DEPARTMENT OF TRANSPORTATION  
DIVISION OF HIGHWAYS - DIVISION 10 DISTRICT 3

MAP #24 SR 2115 STACK RD  
2.67 MILES  
FROM SR 2128 MULLIS RD  
PAST SR 2133 SANDY RIDGE RD

STATE	PROJECT NO.	SHEET NO.	TOTAL SHEETS
N.C.	2025CPT.10.14.20901	10	
F.A. PROJECT NO.			



ENLARGED MUNICIPAL AND SUBURBAN AREAS


UNION COUNTY


NORTH CAROLINA

PREPARED BY THE


NORTH CAROLINA DEPARTMENT OF TRANSPORTATION  
DIVISION OF HIGHWAYS - DIVISION 10 DISTRICT 3

MAP #25 SR 1003 WHITE STORE RD  
1.02 MILES  
FROM PVMT JOINT SR 1005 LANDSFORD RD  
TO ANSON COUNTY LINE

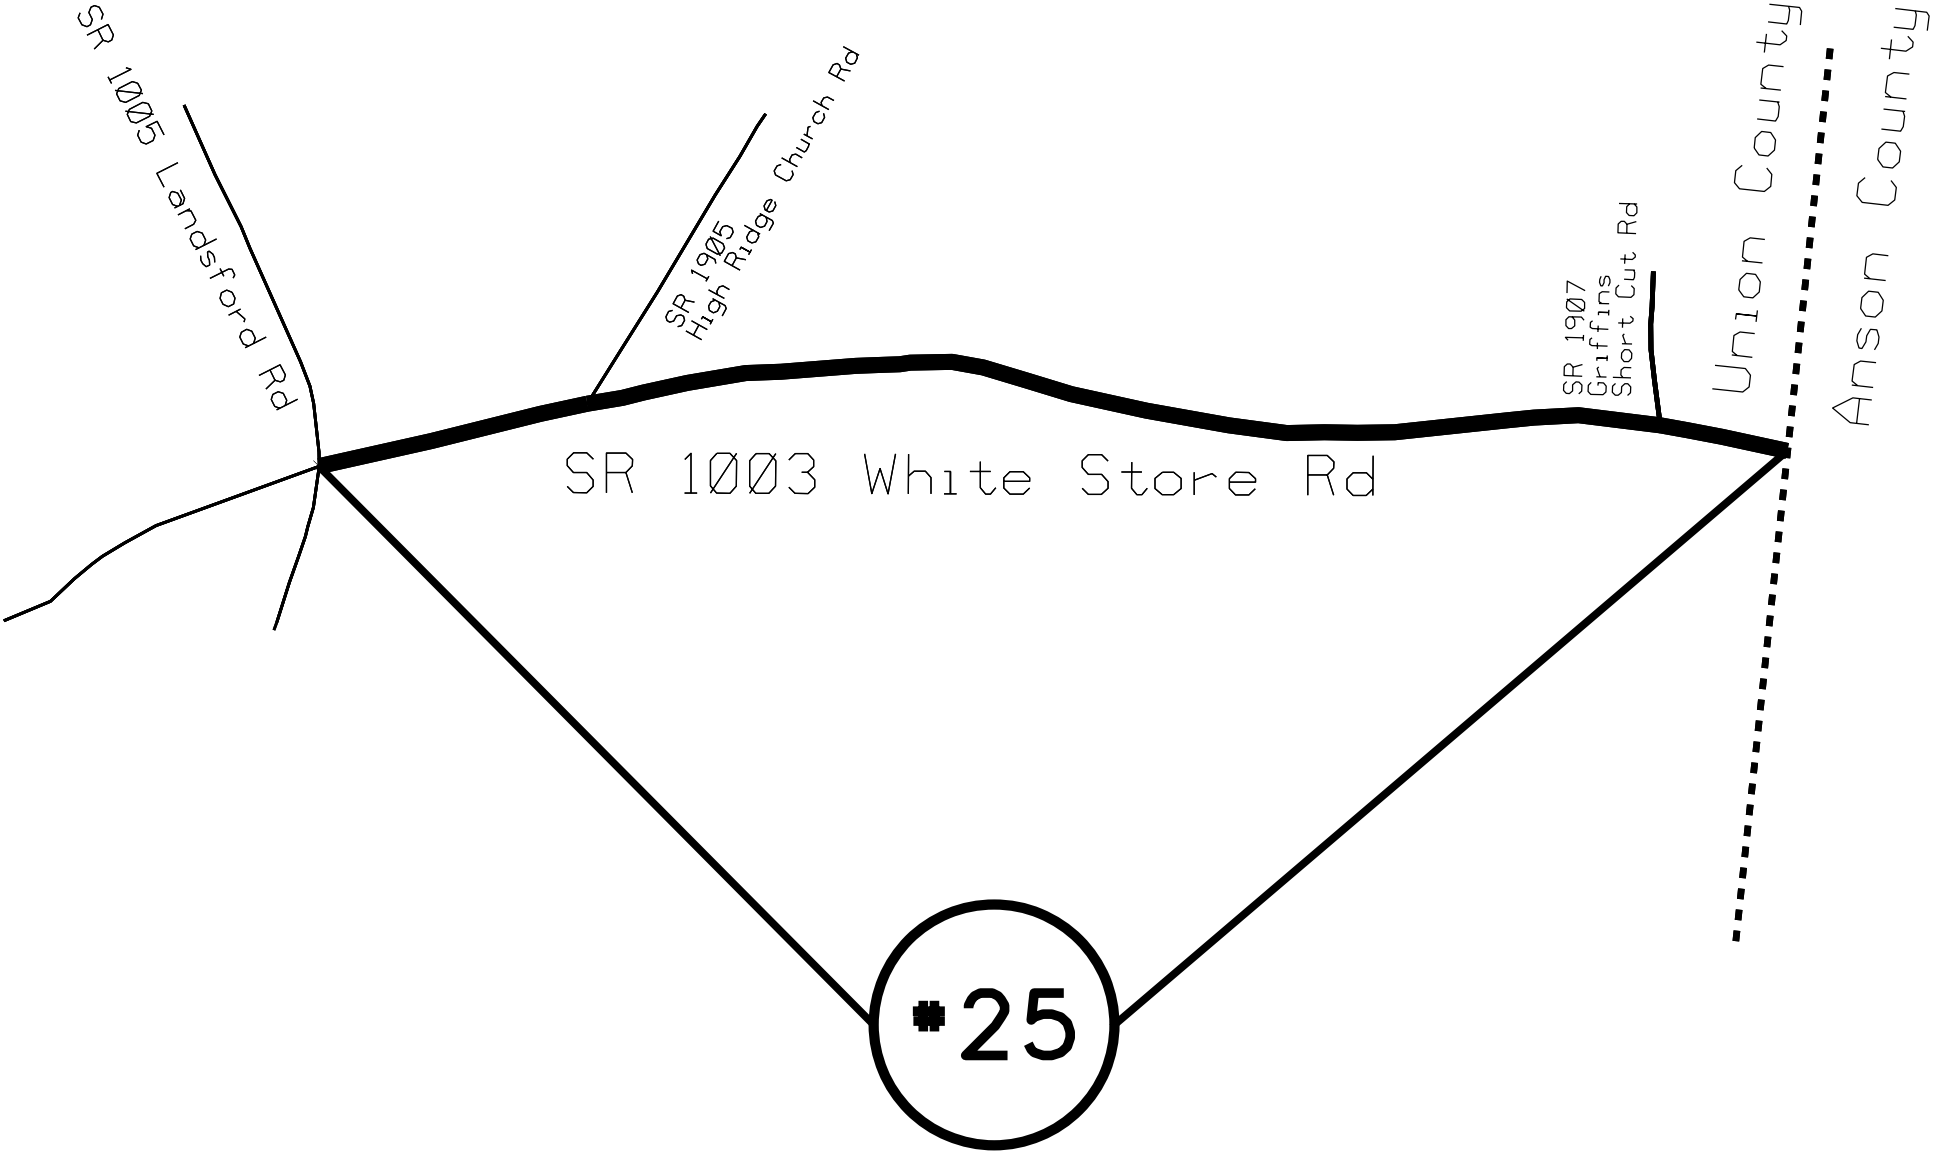

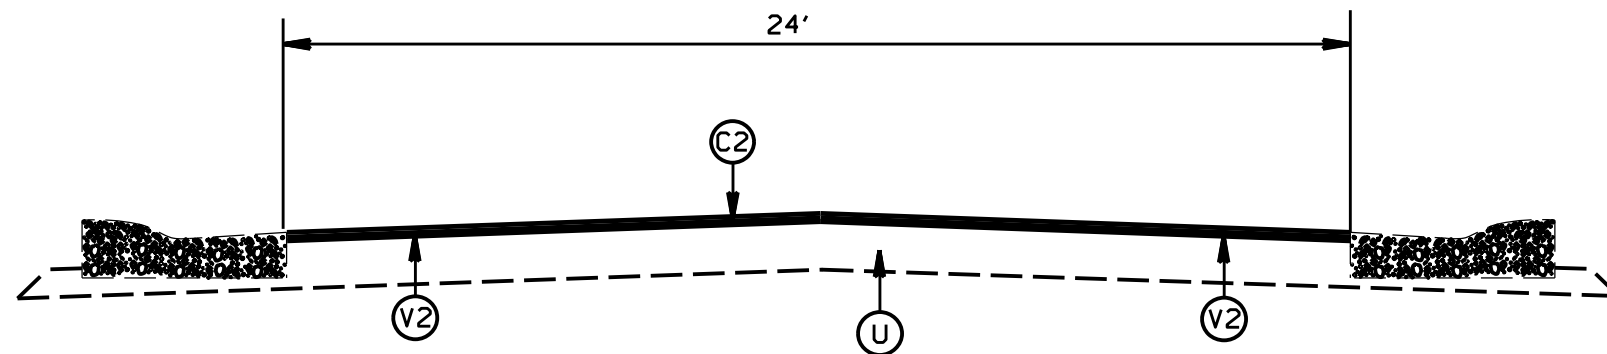

TYPICAL SECTION NO. 1  
 SR 3489 SMOKEY HOLLOW DR (MAP 1)  
 SR 3488 KINDLING WOOD LN (MAP 2)  
 SR 3487 BRIAR PATCH TERRACE (MAP 3)  
 SR 3486 WHEATFIELD DR (MAP 4)  
 SR 3177 GROVES EDGE LN (MAP 5)  
 SR 3331 SILK POND DR (MAP 6)  
 SR 3332 PTARMIGAN CT (MAP 7)  
 SR 3333 MONTANE RUN CT (MAP 8)  
 SR 3330 RESOLUTION CT (MAP 9)  
 SR 3329 PRIMA CORNICE CT (MAP 10)  
 SR 3328 AVANTI DR (MAP 11)

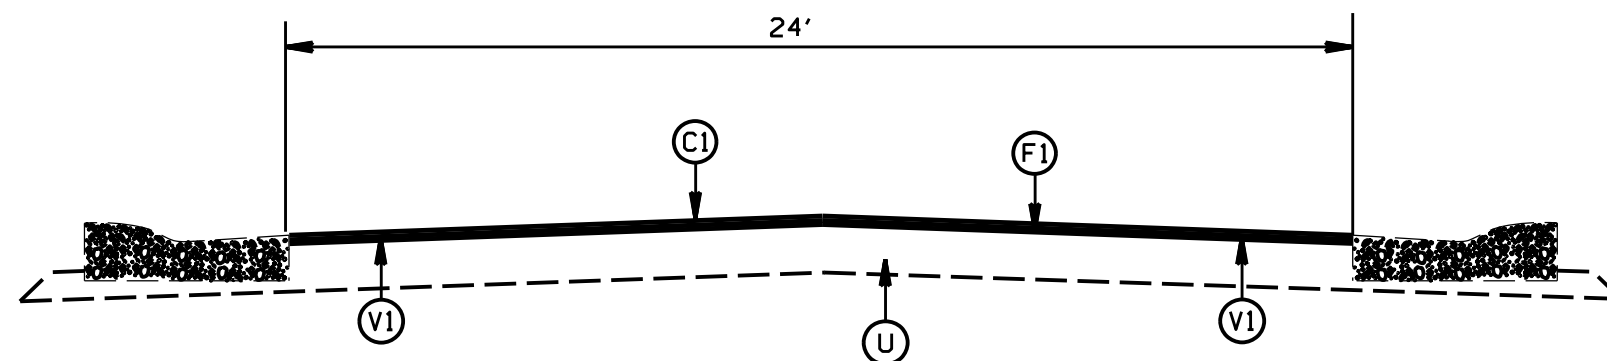

TYPICAL SECTION NO. 2  
 SR 3838 PELHAM LN (MAP 12)  
 SR 3839 BRISTOL CT (MAP 13)  
 SR 3643 STONEHURST LN (MAP 14)  
 SR 3840 CORBIN CT (MAP 16)  
 SR 3641 APPOMATOX DR (MAP 17)  
 SR 3841 MARVIN BRANCH CT (MAP 18)  
 SR 3640 WYNDHAM LN (MAP 19)

STATE	PROJECT NO.	SHEET NO.	TOTAL SHEETS
N.C.	2025CPT.10.14.20901	11	
F.A. PROJECT NO.			

## PAVEMENT SCHEDULE


(C1)	PROP. APPROX. 1.0" ASPHALT CONC. SURFACE COURSE, TYPE S4.75A, AT AN AVERAGE RATE OF 110 LBS. PER SQ. YD.
(C2)	PROP. APPROX. 1.5" ASPHALT CONC. SURFACE COURSE, TYPE S9.5B, AT AN AVERAGE RATE OF 165 LBS. PER SQ. YD.
(C3)	PROP. APPROX. 2.0" ASPHALT CONC. SURFACE COURSE, TYPE S9.5C, AT AN AVERAGE RATE OF 224 LBS PER SQ. YD.
(F1)	ASPHALT SURFACE TREATMENT, DOUBLE SEAL
(F2)	ASPHALT SURFACE TREATMENT, MAT COAT #78M
(T1)	SHOULDER RECONSTRUCTION
(U)	EXISTING PAVEMENT
(V1)	PROFILE MILLING OF EXISTING PAVEMENT, 0" TO 1.0" DEPTH.
(V2)	PROFILE MILLING OF EXISTING PAVEMENT, 0" TO 1.5" DEPTH.
(V3)	MILLING OF EXISTING PAVEMENT, 1.5" DEPTH.

2025  
 UNION COUNTY RESURFACING


SCALE	DATE	DESIGN BY	APPROVED	REVISIONS
NA	11/23	AJB	CLA	



STATE	PROJECT NO.	SHEET NO.	TOTAL SHEETS
N.C.	2025CPT.10.14.20901	12	
F.A. PROJECT NO.			

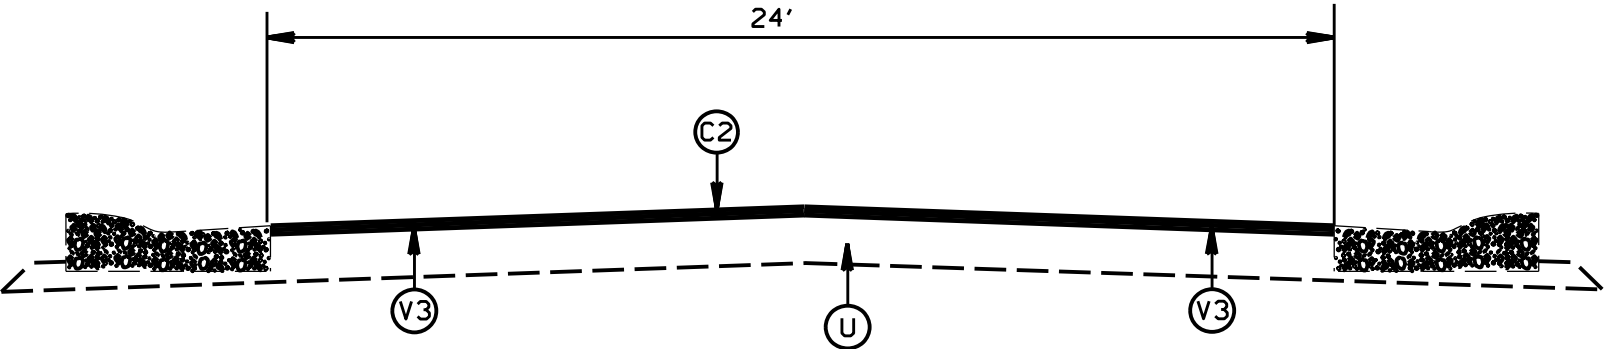


TYPICAL SECTION NO. 3  
 SR 2649 CORPORATE BLVD (MAP 20)  
 SR 2650 BUSINESS PARK DR (MAP 21)  
 SR 2651 ASSOCIATES LN (MAP 22)

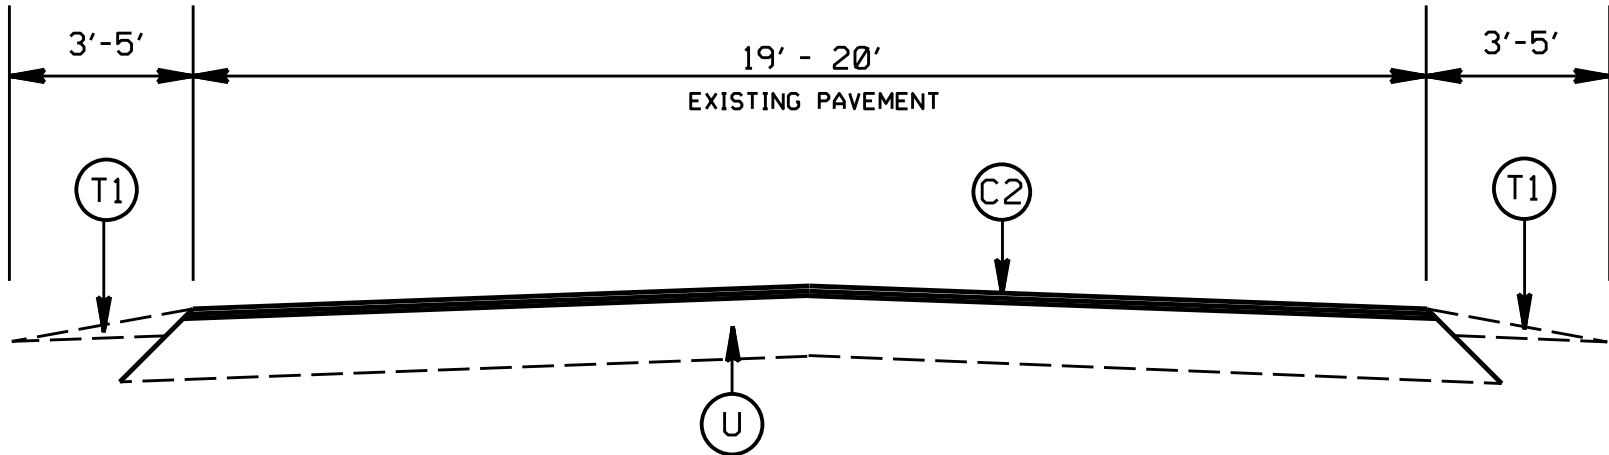


TYPICAL SECTION NO. 4  
 SR 1315 NEW TOWN RD (MAP 23)  
 SR 1003 WHITE STORE RD (MAP 25)

PAVEMENT SCHEDULE

C1	PROP. APPROX. 1.0" ASPHALT CONC. SURFACE COURSE, TYPE S4.75A, AT AN AVERAGE RATE OF 110 LBS. PER SQ. YD.
C2	PROP. APPROX. 1.5" ASPHALT CONC. SURFACE COURSE, TYPE S9.5B, AT AN AVERAGE RATE OF 165 LBS. PER SQ. YD.
C3	PROP. APPROX. 2.0" ASPHALT CONC. SURFACE COURSE, TYPE S9.5C, AT AN AVERAGE RATE OF 224 LBS PER SQ. YD.
F1	ASPHALT SURFACE TREATMENT, DOUBLE SEAL
F2	ASPHALT SURFACE TREATMENT, MAT COAT #78M
T1	SHOULDER RECONSTRUCTION
U	EXISTING PAVEMENT
V1	PROFILE MILLING OF EXISTING PAVEMENT, 0" TO 1.0" DEPTH.
V2	PROFILE MILLING OF EXISTING PAVEMENT, 0" TO 1.5" DEPTH.
V3	MILLING OF EXISTING PAVEMENT, 1.5" DEPTH.


<div>2025</div> <div>UNION COUNTY RESURFACING</div>			
SCALE	NA		REVISIONS
DATE	11/23		
DWG. BY	AJB		
DESIGN BY	AJB		
APPROVED	CLA		

STATE	PROJECT NO.	SHEET NO.	TOTAL SHEETS
N.C.	2025CPT.10.14.20901	13	
F.A. PROJECT NO.			

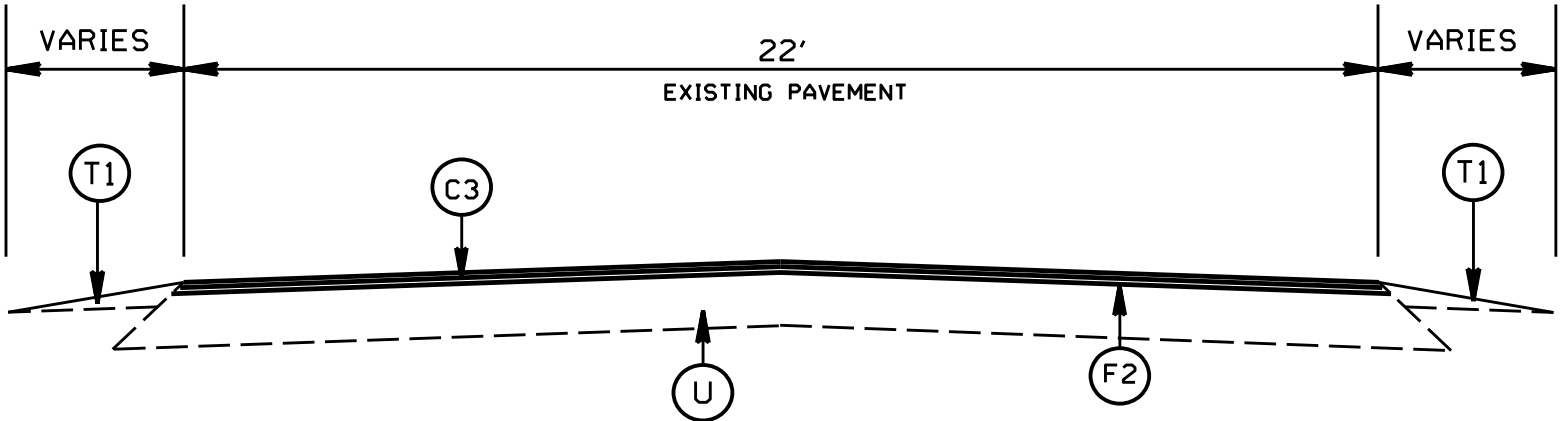

TYPICAL SECTION NO. 5

SR 2115 STACK RD (MAP 24)  
APPROX STA 10+00 TO 132+77  
APPROX STA 133+12 TO 150+98

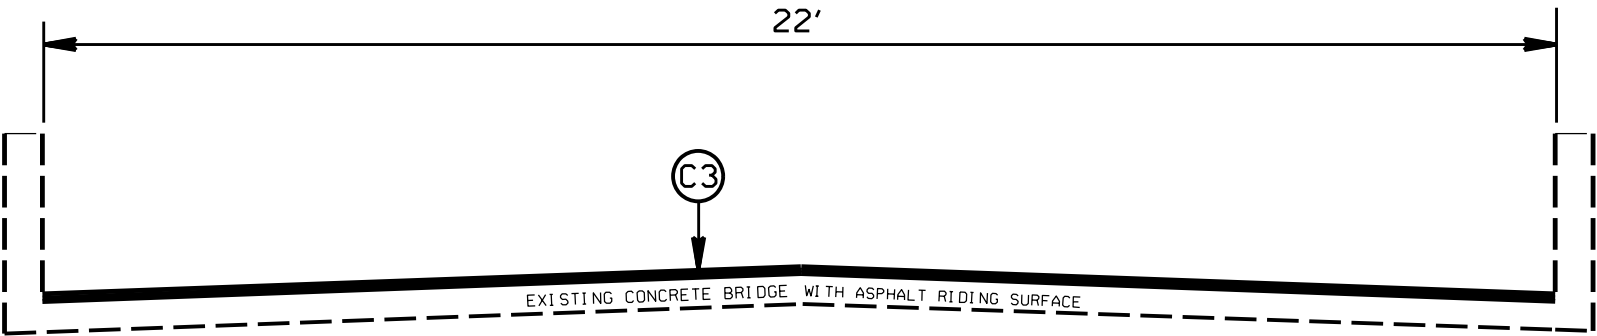

TYPICAL SECTION NO. 6

SR 2115 STACK RD (MAP 24)  
APPROX STA 132+77 TO 133+12  
NO #78M MAT COAT ON BRIDGE  
ASPHALT OVERLAY ONLY

PAVEMENT SCHEDULE

(C1)	PROP. APPROX. 1.0" ASPHALT CONC. SURFACE COURSE, TYPE S4.75A, AT AN AVERAGE RATE OF 110 LBS. PER SQ. YD.
(C2)	PROP. APPROX. 1.5" ASPHALT CONC. SURFACE COURSE, TYPE S9.5B, AT AN AVERAGE RATE OF 165 LBS. PER SQ. YD.
(C3)	PROP. APPROX. 2.0" ASPHALT CONC. SURFACE COURSE, TYPE S9.5C, AT AN AVERAGE RATE OF 224 LBS PER SQ. YD.
(F1)	ASPHALT SURFACE TREATMENT, DOUBLE SEAL
(F2)	ASPHALT SURFACE TREATMENT, MAT COAT #78M
(T1)	SHOULDER RECONSTRUCTION
(U)	EXISTING PAVEMENT
(V1)	PROFILE MILLING OF EXISTING PAVEMENT, 0" TO 1.0" DEPTH.
(V2)	PROFILE MILLING OF EXISTING PAVEMENT, 0" TO 1.5" DEPTH.
(V3)	MILLING OF EXISTING PAVEMENT, 1.5" DEPTH.

2025  
UNION COUNTY RESURFACING

SCALE	DATE	DESIGN BY	APPROVED	REVISIONS
-N/A-	11/23	AJB	CLA	




# NOTES:

STATE	PROJECT NO.	SHEET NO.	TOTAL SHEETS
N.C.	2025CPT.10.14.20901	14	
F.A. PROJECT NO.			


1. DEPTH OF PATCHING WILL BE AS DIRECTED BY THE ENGINEER.
2. SHOULDER RECONSTRUCTION WILL BE AS DIRECTED BY THE ENGINEER.
3. DO NOT REMOVE OR DAMAGE THE EXISTING SPEED CUSHIONS ON MAPS 2, 4, AND 5. PROTECT EXISTING PVMT MARKINGS ON THE CUSHIONS DURING RESURFACING OPERATIONS, ANY DAMAGE TO THE CUSHIONS OR MARKINGS WILL BE REPLACE/REPAIRED AT THE CONTRACTORS EXPENSE. MILL AS NEEDED TO PROVIDE A SMOOTH TRANSITION TO TIE THE ASPHALT OVERLAY TO THE SPEED CUSHION.
4. INSTALL WCR ON MAP 2 (KINDLING WOOD LN) AT THE EXISTING CROSSWALK, WHERE MAP 1 (BRIAR PATCH TERRACE) AND KINDLING WOOD CONNECT.
5. RETROFIT EXISTING CURB RAMPS ON MAPS 7, 8, 9, 10, AND 11.
6. REMOVE AND REPLACE CURB AS IDENTIFIED BY THE ENGINEER ON MAPS 20, 21, AND 22.
7. MAP 24 (STACK RD), DO NOT PLACE #78 MAT COAT ON THE BRIDGE. CONTRACTOR WILL NEED TO STOP PLACEMENT OF THE MAT COAT IN A MANNER TO PROVIDE A SMOOTH TRANSITION FOR THE ASPHALT OVERLAY ACROSS THE BRIDGE.

2025 UNION COUNTY RESURFACING			
SCALE	DATE	DESIGN BY	APPROVED
1"=40'	01/20	AMO	CLA
REVISIONS			


STATE	PROJECT NO.	SHEET NO.	TOTAL SHEETS
N.C.	2025CPT.10.14.20901	15	

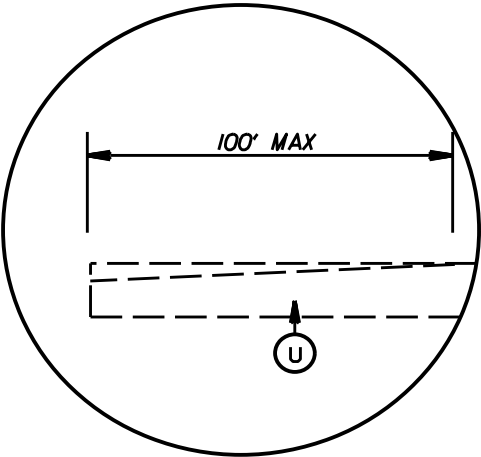


DETAIL FOR INCIDENTAL MILLING (0" TO 2.0")

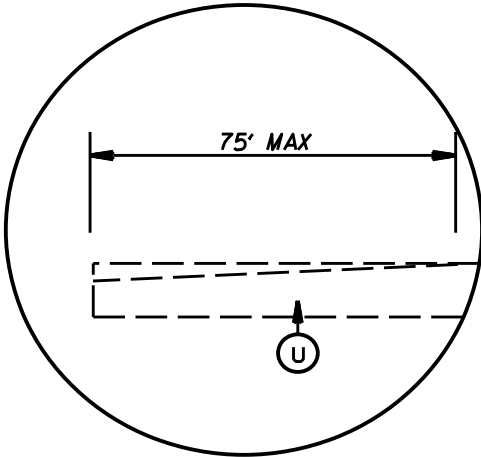

DETAIL FOR INCIDENTAL MILLING (0" TO 1.5")

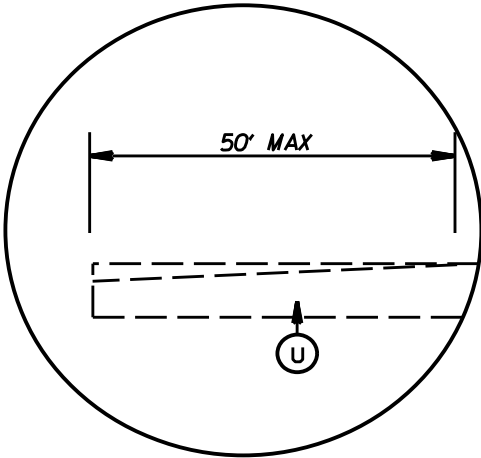


DETAIL FOR INCIDENTAL MILLING (0" TO 1.0")

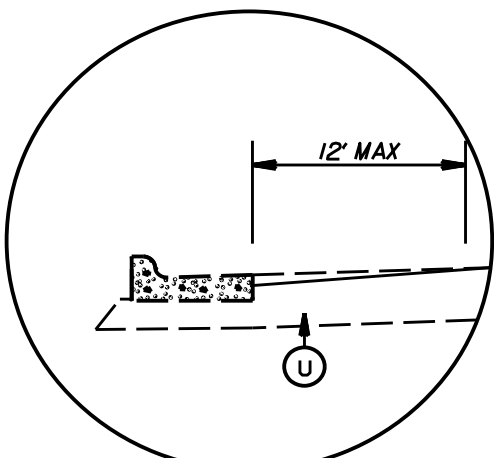

DETAIL FOR PROFILE MILLING


PATCHING DETAIL

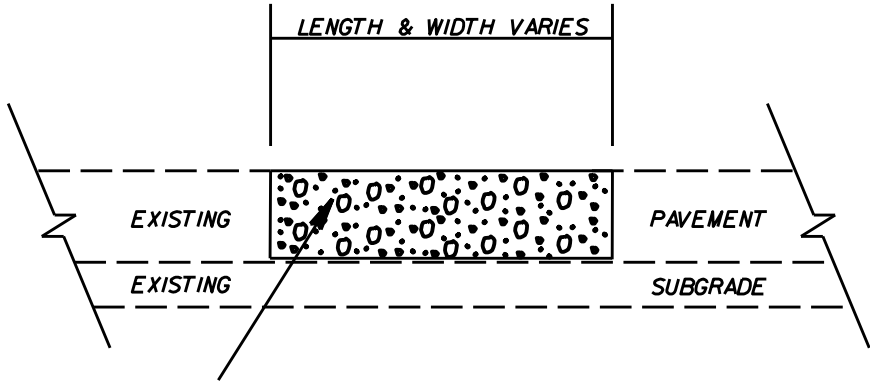

RATE IS VARIABLE AND SHALL BE AS DIRECTED BY THE ENGINEER. ASPHALT TYPE 119.0C SHALL BE PLACED.


PAVEMENT SCHEDULE

(C1)	PROP. APPROX. 1.0" ASPHALT CONC. SURFACE COURSE, TYPE S4.75A, AT AN AVERAGE RATE OF 110 LBS. PER SQ. YD.
(C2)	PROP. APPROX. 1.5" ASPHALT CONC. SURFACE COURSE, TYPE S9.5B, AT AN AVERAGE RATE OF 165 LBS. PER SQ. YD.
(C3)	PROP. APPROX. 2.0" ASPHALT CONC. SURFACE COURSE, TYPE S9.5C, AT AN AVERAGE RATE OF 224 LBS PER SQ. YD.
(F1)	ASPHALT SURFACE TREATMENT, DOUBLE SEAL
(F2)	ASPHALT SURFACE TREATMENT, MAT COAT *78M
(T1)	SHOULDER RECONSTRUCTION
(U)	EXISTING PAVEMENT
(V1)	PROFILE MILLING OF EXISTING PAVEMENT, 0" TO 1.0" DEPTH.
(V2)	PROFILE MILLING OF EXISTING PAVEMENT, 0" TO 1.5" DEPTH.
(V3)	MILLING OF EXISTING PAVEMENT, 1.5" DEPTH.

2025 UNION COUNTY RESURFACING			
SCALE	NA		REVISIONS
DATE	1/20		
DWG. BY	AMO		
DESIGN BY	AMO		
APPROVED	CLA		


INTERSECTION EMULSION PLACEMENT  
TWO LANE TWO WAY ROADWAY

STATE	PROJECT NO.	SHEET NO.	TOTAL SHEETS
N.C.	2025CPT.10.14.20901	16	
F.A. PROJECT NO.			

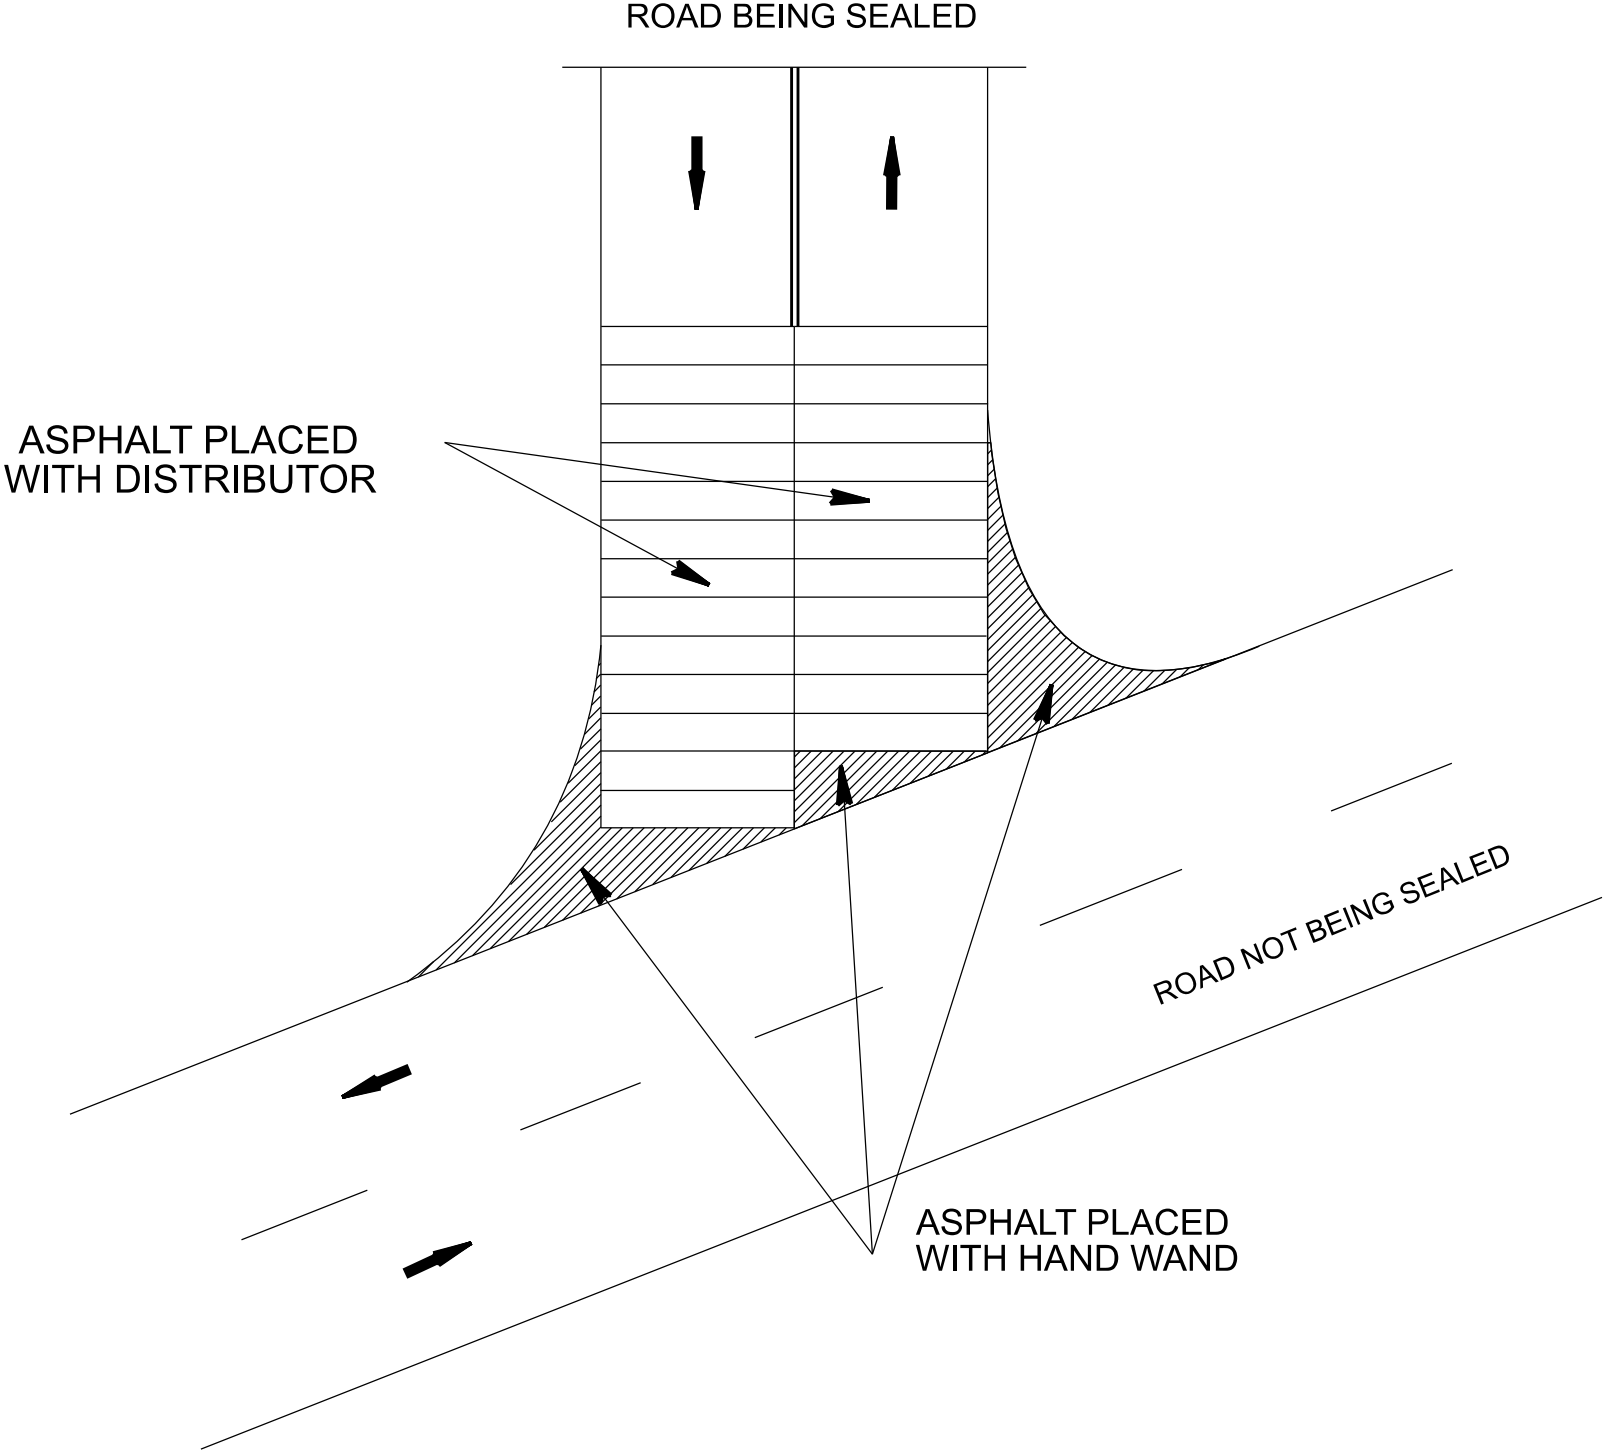

LEGEND

- ➡ DIRECTION OF TRAFFIC FLOW
- SKIP LINES
- == DOUBLE YELLOW LINES


INTERSECTION EMULSION PLACEMENT			
SCALE	-NA-		REVISIONS
DATE	9/19		
DWG. BY	TBL		
DESIGN BY	TBL		
APPROVED	TWB		



NOTES:


- 1) DETAIL DOES NOT APPLY TO OGAF C AND ULTRA-THIN BONDED WEARING COURSE.
- 2) BACKFILL SHOULDER WITH APPROVED MATERIAL.
- 3) THE SHOULDER WEDGE DEVICE MAY BE DISENGAGED AT PAVED DRIVEWAYS AND SIDE STREETS.

STATE	PROJECT NO.	SHEET NO.	TOTAL SHEETS
N.C.	2025CPT.10.14.20901	17	
F.A. PROJECT NO.			

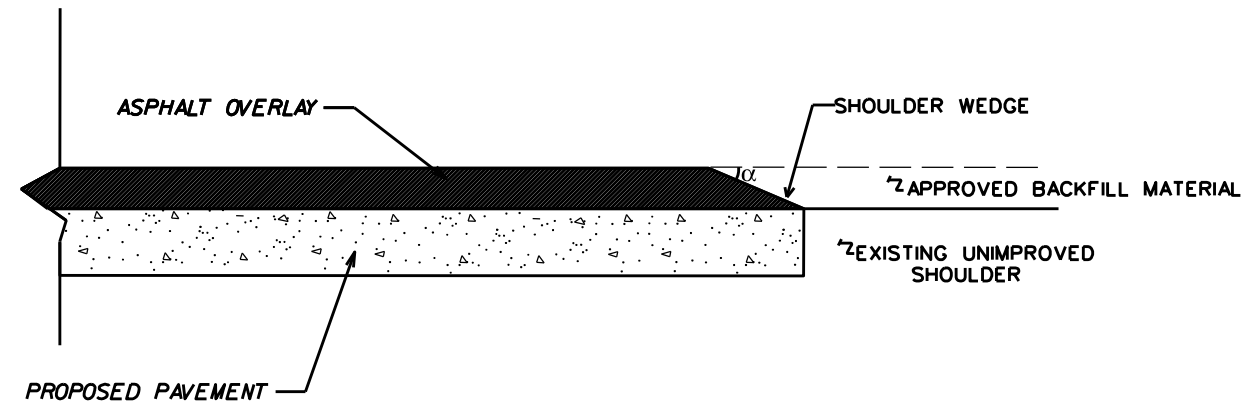


SHOULDER WEDGE DETAIL

(RESURFACING PROJECTS W/ WIDENING OR WITH EXISTING PAVED SHOULDER HAVING NO DROPOFFS)

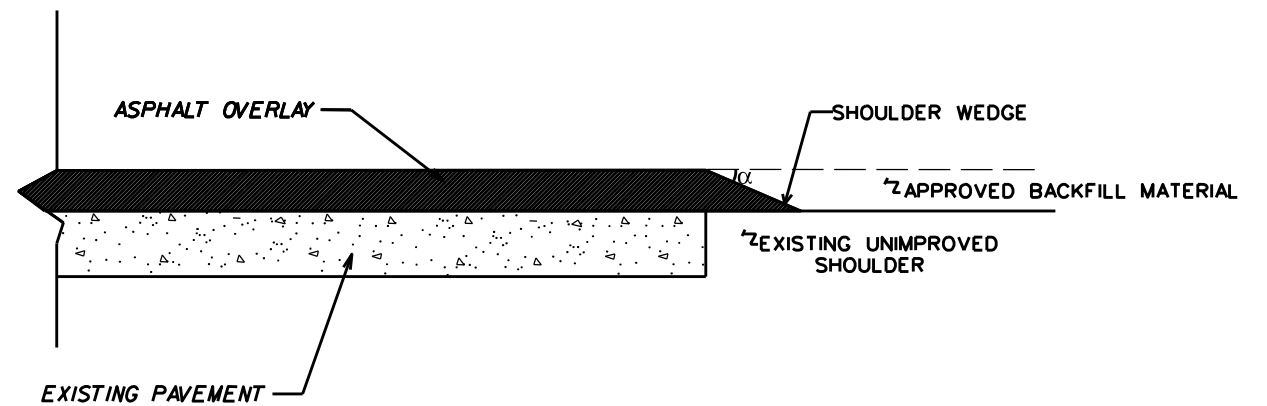


SHOULDER WEDGE DETAIL


(RESURFACING PROJECTS W/ NO WIDENING)

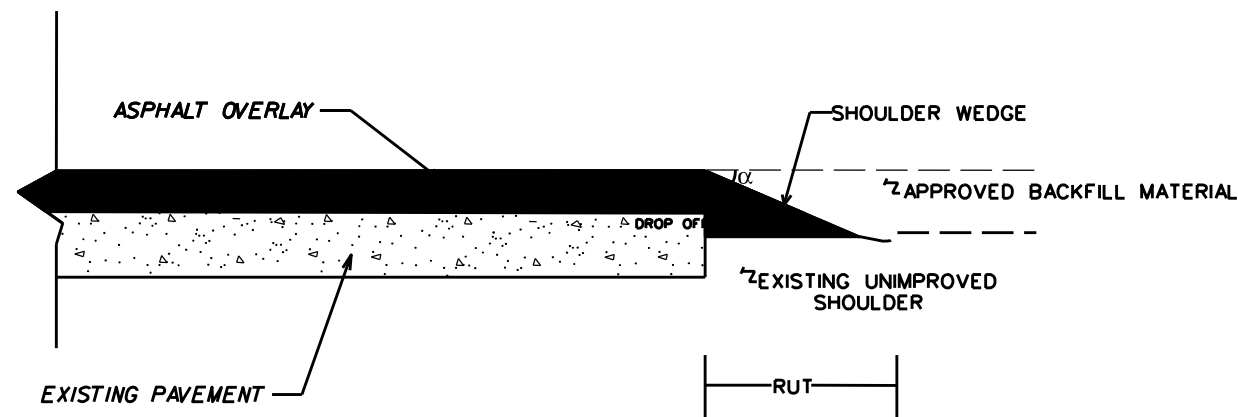


SHOULDER WEDGE DETAIL  
(RESURFACING ADJACENT TO RUTTED SHOULDER)

$\alpha = 30 \text{ DEGREES}$

SHOULDER WEDGE DETAILS				
SCALE	1/4"		REVISIONS	
DATE	08/18			
DWG. BY	AMO			
DESIGN BY	AMO			
APPROVED	CLA			

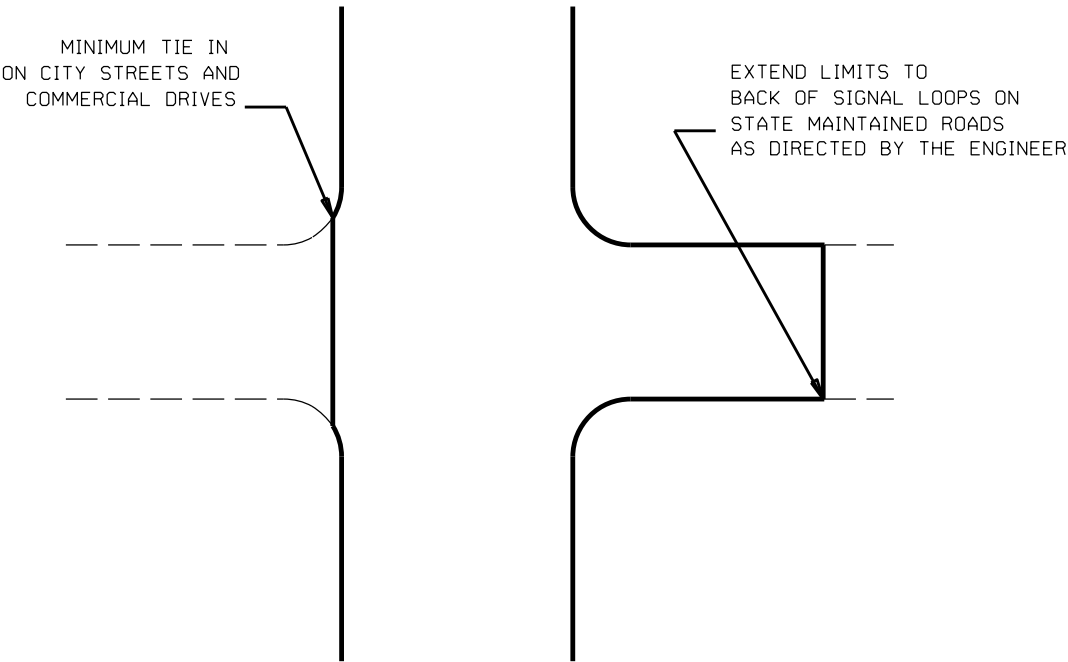

TYPICAL DETAIL OF PROJECT LIMITS AT  
SIGNALIZED Y LINES

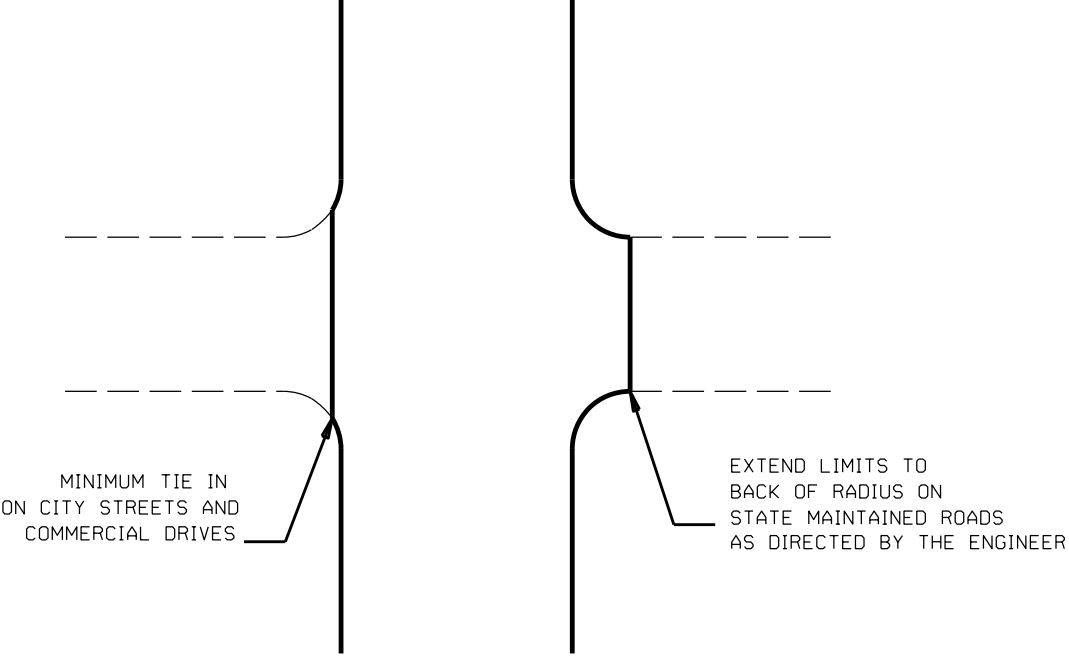

TYPICAL DETAIL OF PROJECT LIMITS AT  
UNSIGNALIZED Y LINES

ADDITIONAL INTERSECTIONS (NON-TYPICAL)		
Extend paving limits to back of radius or loop on the following intersections:		
MAP*	STREET NAME	COMMENTS
MAP 23	SR 1160 CLARK RD	
MAP 23	SR 1249 EDGEHILL DR	
MAP 23	SR 1157 FLETCHER BROOME RD	
MAP 24	SR 2130 ARMFIELD MILL RD	
MAP 24	SR 2176 PARKS MEDLIN RD	
MAP 24	SR 2131 TROY MEDLIN RD	
MAP 24	SR 2132 BRUCE THOMAS RD	
MAP 24	SR 2134 CHARLIE WILLIAMS RD	
MAP 24	SR 2133 SANDY RIDGE RD	
MAP 24	SR 1905 HIGH RIDGE CHURCH RD	
MAP 24	SR 1907 GRIFFIN SHORTCUT RD	

# WATTLE WITH POLYACRYLAMIDE DETAIL

## NOTES:

USE MINIMUM 12 IN. DIAMETER EXCELSIOR WATTLE.

USE 2 FT. WOODEN STAKES WITH A 2 IN. BY 2 IN. CROSS SECTION.

INSTALL A MINIMUM OF 2 UPSLOPE STAKES AND 4 DOWNSLOPE STAKES AT AN ANGLE TO WEDGE WATTLE TO BOTTOM OF DITCH.







PROVIDE STAPLES MADE OF 0.125 IN. DIAMETER STEEL WIRE FORMED INTO A U SHAPE NOT LESS THAN 12" IN LENGTH.

INSTALL STAPLES APPROXIMATELY EVERY 1 LINEAR FOOT ON BOTH SIDES OF WATTLE AND AT EACH END TO SECURE IT TO THE SOIL.

INSTALL MATTING IN ACCORDANCE WITH SECTION 1631 OF THE STANDARD SPECIFICATIONS.


PRIOR TO POLYACRYLAMIDE (PAM) APPLICATION, OBTAIN A SOIL SAMPLE FROM PROJECT LOCATION, AND FROM OFFSITE MATERIAL, AND ANALYZE FOR APPROPRIATE PAM FLOCCULANT TO BE APPLIED TO EACH WATTLE.

INITIALLY APPLY 3.5 OUNCES OF ANIONIC OR NEUTRALLY CHARGED POLYACRYLAMIDE (PAM) OVER WATTLE WHERE WATER WILL FLOW AND AFTER EVERY RAINFALL EVENT THAT IS EQUAL TO OR EXCEEDS 0.50 IN.

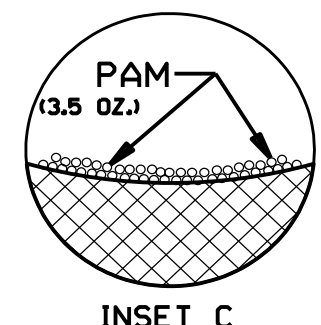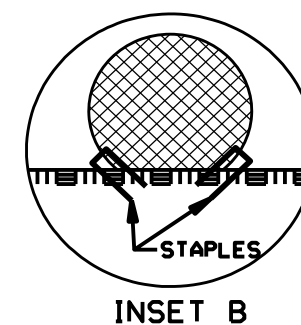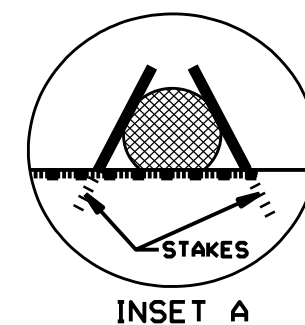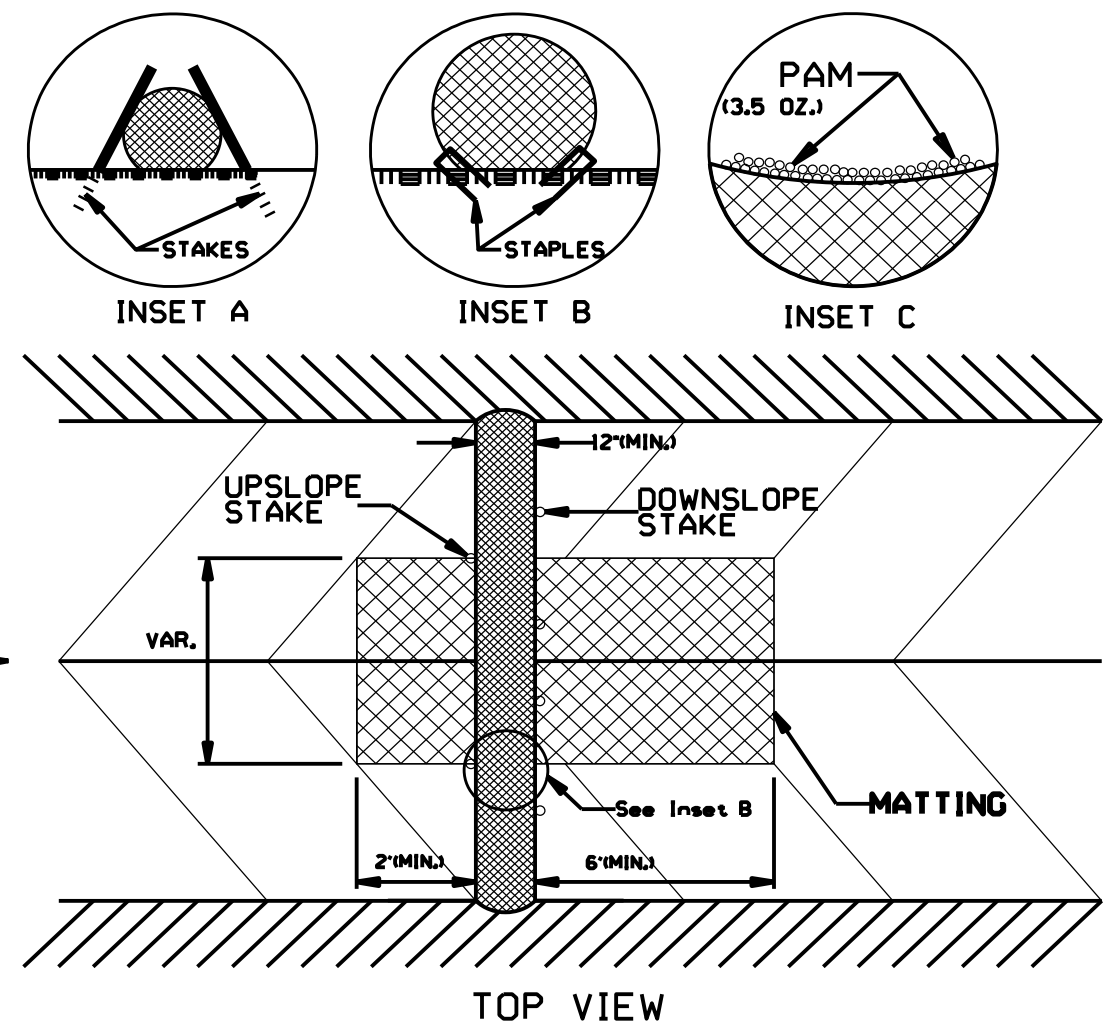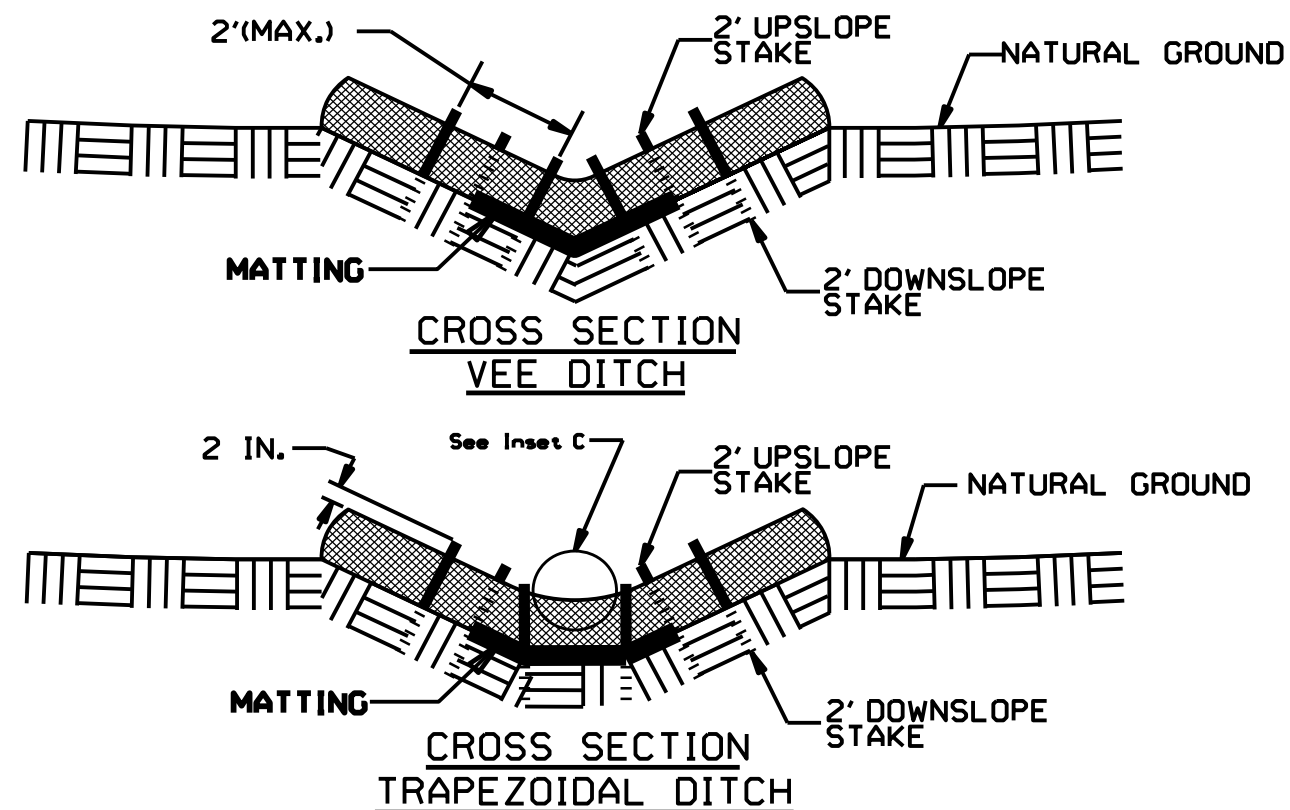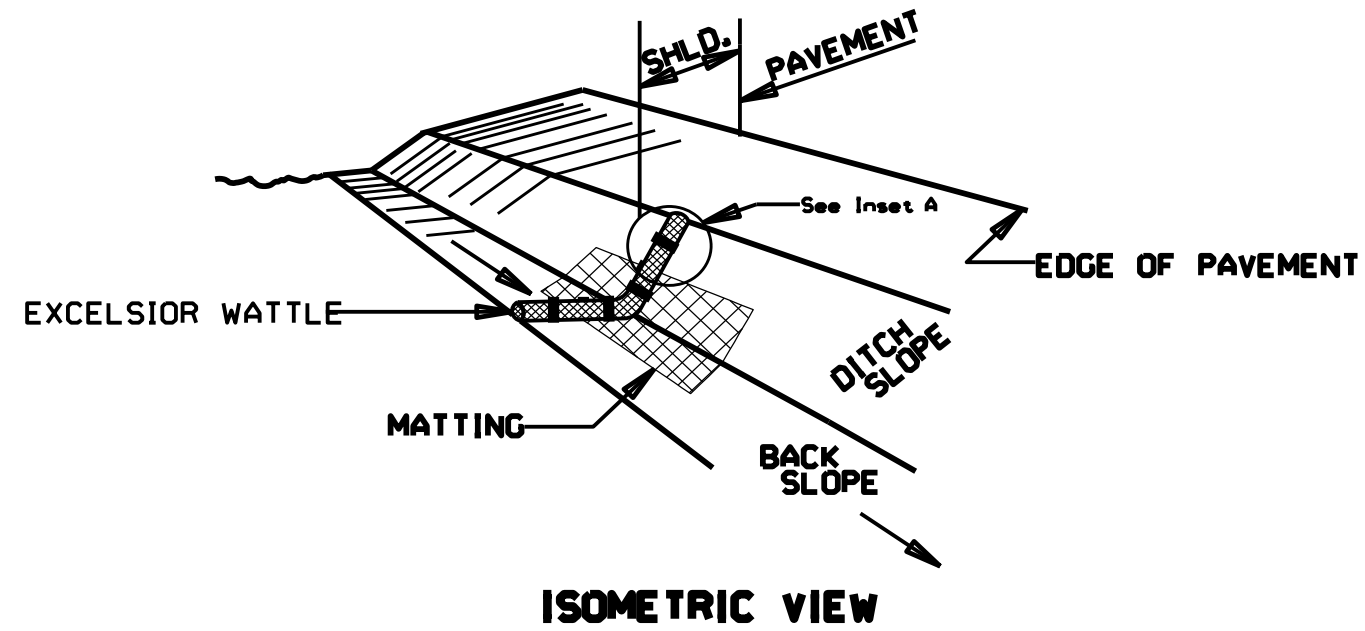


NOTES: LESS THAN 5' - 10' UNDISTURBED BUFFER FROM ROW, DITCHLINE, WATER FEATURE, OR DRAINAGE INLET, ADD BMP.

BMP OPTIONS: WATTLE OR SILT FENCE

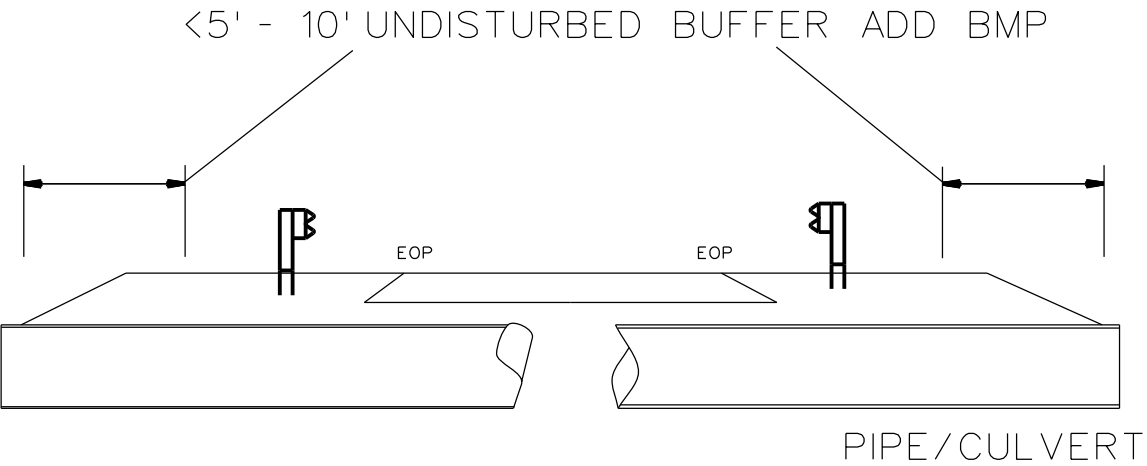


<5' - 10' UNDISTURBED BUFFER FROM JURISDICTIONAL FEATURE ADD BMP

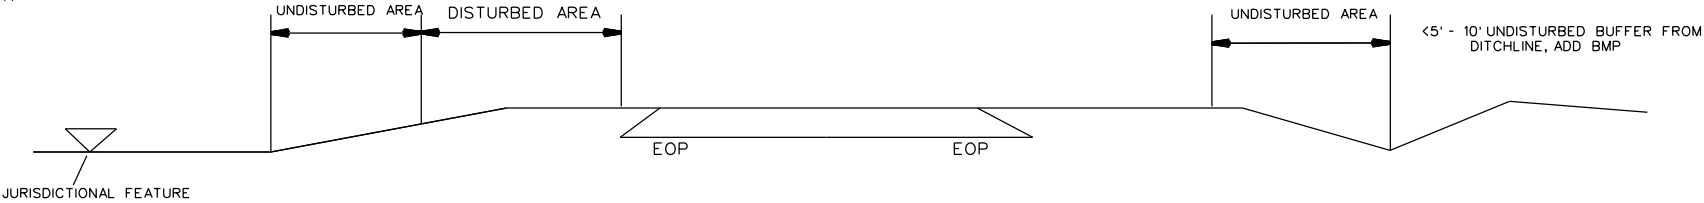


USE BMP'S IF SHOULDERS AND/OR FRONTSLOPES AND/OR DITCHLINE AND/OR BACKSLOPES ARE DISTURBED



<5' - 10' UNDISTURBED BUFFER FROM INLET, ADD WATTLE

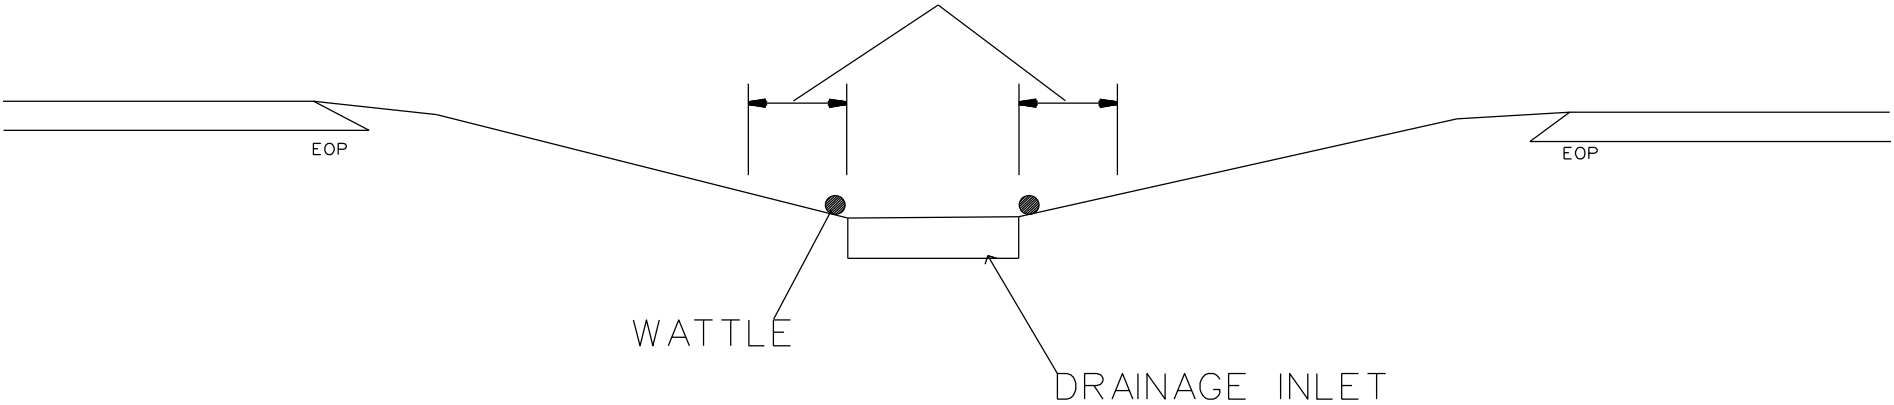



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N.C.	2025CPT.10.14.20901	EC2	
F.A. PROJECT NO.			


EROSION CONTROL DETAIL			
SCALE	NA		REVISIONS
DATE	1/20		
DESIGNED BY	AMO		
DESIGN BY	AMO		
APPROVED	CLA		



SIGNING FOR ASPHALT SURFACE TREATMENT

LEGEND

 PORTABLE SIGN

 STATIONARY SIGN


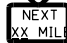


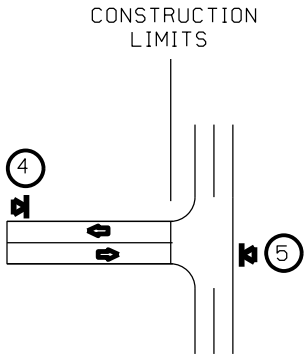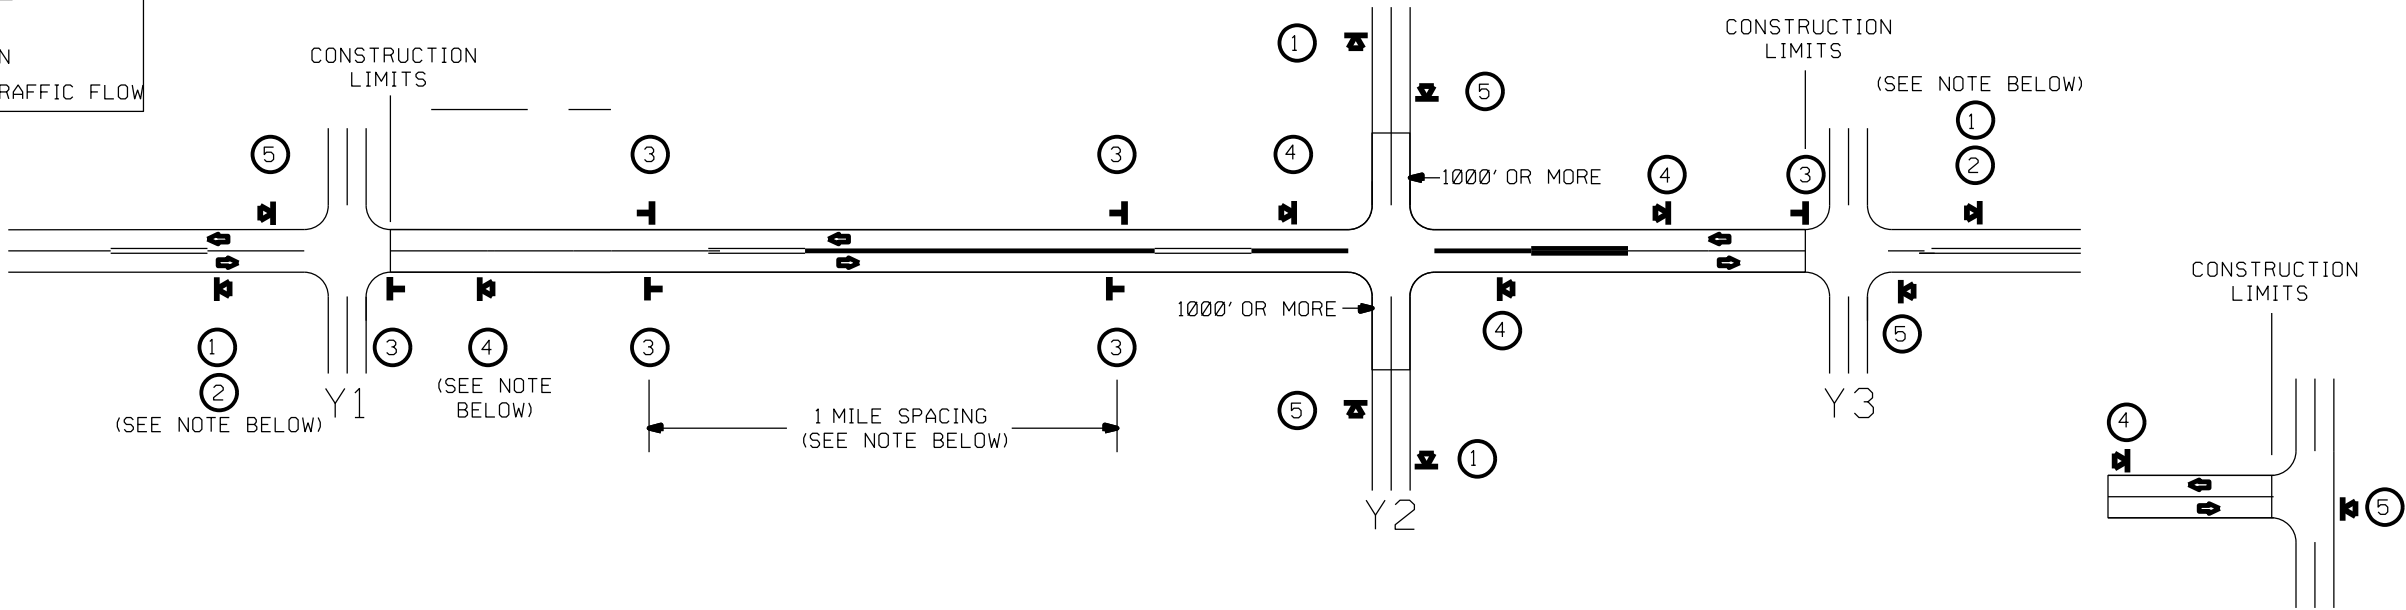


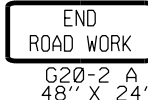
 DIRECTION OF TRAFFIC FLOW



TEE INTERSECTION

MAINLINE (-L-) SIGNING

-Y- LINE SIGNING

SIGNING NOTES AND PLACEMENT PER DIRECTION	<div><div>①</div><div><div>W20-1 48" X 48"</div></div></div> <div><div>②</div><div><div>W7-3aP 24" X 18"</div></div></div> <div><p>- PLACE 1000' PRIOR TO BEGINNING OF CONSTRUCTION LIMITS. ONLY USED ON -Y- LINES IF RESURFACING LIMITS EXTEND 1000' ALONG -Y- LINE.</p><p>- SIGN #2 ONLY USED WHEN RESURFACING LIMITS ARE 2 OR MORE MILES IN LENGTH. ROUND UP TO THE NEAREST WHOLE NUMBER. DO NOT USE FRACTIONAL OR DECIMAL NUMBERS.</p></div>	STATIONARY SIGNING NOT REQUIRED FOR THE FOLLOWING -Y- LINE CONDITIONS:
	<div><div>③</div><div><div><div>W8-7 48" X 48"</div></div><div><div>SP 48" X 48"</div></div></div><div><p>- ALTERNATE THE FOLLOWING TWO SIGNS:</p><p>- STARTING WITH "LOOSE GRAVEL" (W8-7) FOLLOWED BY "UNMARKED PAVEMENT".</p><p>- PLACE INITIALLY AT THE CONSTRUCTION LIMITS AND SPACED 1 MILE APART THEREAFTER.</p><p>- AT TEE INTERSECTIONS INSTALL INITIALLY 0.5 MILE FROM INTERSECTION AND SPACE 1 MILE APART THEREAFTER.</p></div></div>	WHEN PAVING/CONSTRUCTION ACTIVITIES PROCEED ACROSS AN UNSIGNED -Y- LINE, PORTABLE ADVANCE WARNING SIGNS SHALL BE USED ALONG THE -Y- LINE AS SHOWN BELOW. REMOVE UPON COMPLETION OF WORK.
	<div><div>④</div><div><div>SP 13106 48" X 48"</div></div></div> <div><p>- THESE ARE FOR -Y- LINES THAT ARE "THROUGH" ROADWAYS. DEAD END AND SUBDIVISION ROADS ARE NOT "THROUGH" ROADWAYS.</p><p>- INSTALL 500' +/- FROM EACH -Y- LINE APPROACH AS SHOWN ABOVE.</p><p>- FOR MULTIPLE -Y- LINES THAT ARE SEPARATED BY 0.25 MILES OR LESS, TREAT AS A SINGLE UNIT AND INSTALL WITHIN 500' OF EACH APPROACH.</p><p>- A MAXIMUM OF 2 SIGN SETS PER MILE. DO NOT INSTALL WHEN -Y- LINES ARE WITHIN 0.5 MILES FROM "END ROAD WORK" SIGN.</p></div>	<div><div>W20-1 48" X 48"</div></div> <div>PLACED 500' IN ADVANCE OF FLAGGER.</div> <div><div>W20-7 A 48" X 48"</div></div> <div>PLACED 250' IN ADVANCE OF FLAGGER.</div>
	<div><div>⑤</div><div><div>G20-2 A 48" X 24"</div></div></div> <div>PLACE 500' FOLLOWING THE END OF CONSTRUCTION LIMITS OR AS SHOWN WHEN WORK ENDS AT A 3-WAY TEE INTERSECTION.</div>	
		THE ABOVE SIGNS ARE ALL THAT ARE REQUIRED FOR A CONTRACTOR TO BEGIN A RESURFACING CONTRACT. ANY ADDITIONAL SIGNS REQUESTED BY NCDOT DIVISIONS SHALL BE INSTALLED WITHIN 7 BUSINESS DAYS OF THE START OF CONTRACT WORK.


MAPS LESS THAN 2 MILES	FOR AST RESURFACING MAPS WITH CONSTRUCTION LIMITS LESS THAN 2 MILES IN LENGTH, USE A STATIONARY "LOOSE GRAVEL" SIGN AT THE BEGINNING CONSTRUCTION LIMIT FOLLOWED BY AN "UNMARKED PAVEMENT" SIGN MIDWAY THROUGH AND AN "END ROAD WORK" SIGN AT THE END CONSTRUCTION LIMIT.
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DIVISION OF HIGHWAYS


STATE OF NORTH CAROLINA

DEPARTMENT OF TRANSPORTATION

WORK ZONE TRAFFIC CONTROL



ASR

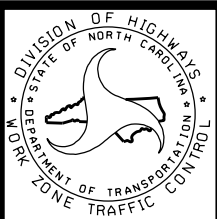



ADVANCE WARNING SIGNS  
FOR  
2-LANE ROADWAY  
ASPHALT SURFACE TREATMEN

SIGNING FOR RESURFACING PROJECTS

LEGEND

STATIONARY SIGN


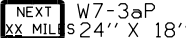


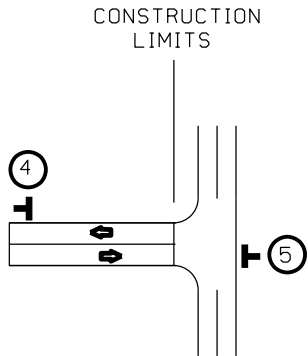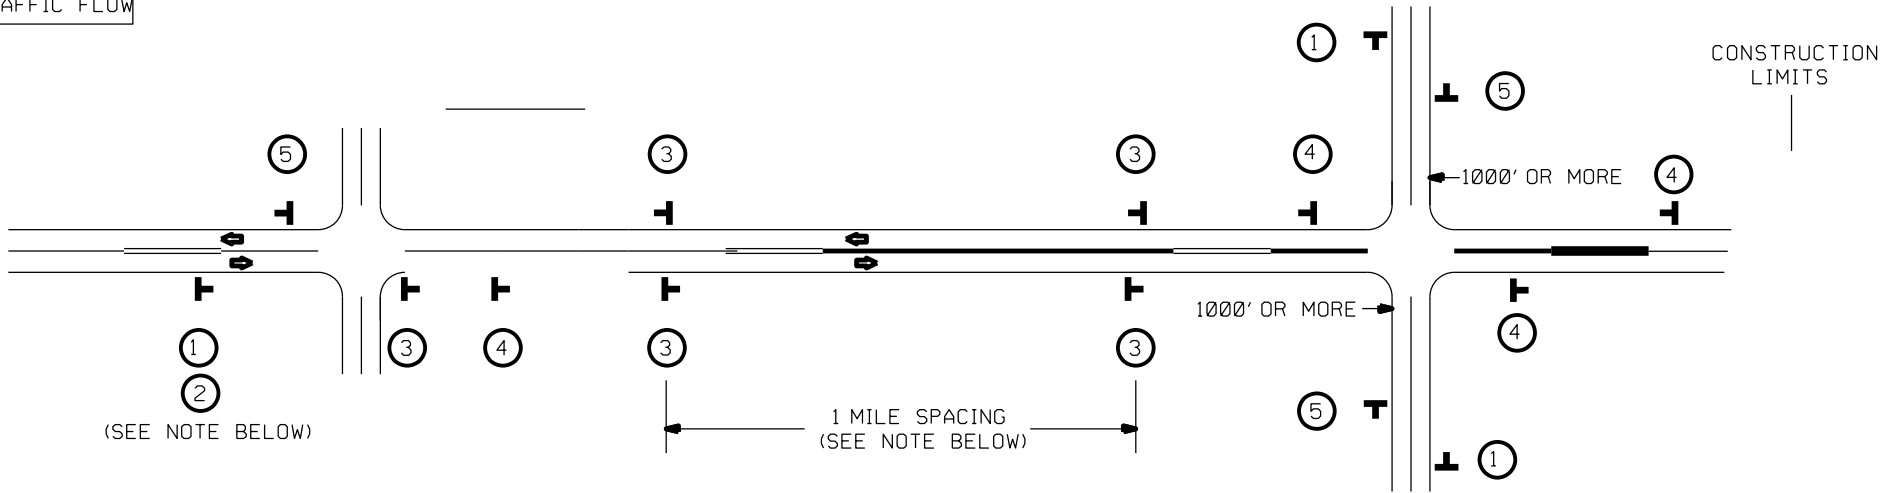


DIRECTION OF TRAFFIC FLOW




TEE INTERSECTION


MAINLINE (-L-) SIGNING

-Y- LINE SIGNING

SIGNING NOTES AND PLACEMENT PER DIRECTION	<div>1</div> <div>2</div> <div> </div>	PLACE 1000' PRIOR TO BEGINNING OF CONSTRUCTION LIMITS. ONLY USED ON -Y- LINES IF RESURFACING LIMITS EXTEND 1000' ALONG -Y- LINE.	NO REQUIRED STATIONARY SIGNING FOR THE FOLLOWING -Y- LINE CONDITIONS:  1) LESS THAN 1000' OF RESURFACING ALONG -Y- LINE 2) SUBDIVISION ROADS 3) DEAD END ROADS		
	<div>3</div> <div> SP 13107 48" X 48"</div>				
	<div>4</div> <div> SP 13106 48" X 48"</div>	<div>- THESE ARE FOR -Y- LINES THAT ARE "THROUGH" ROADWAYS.</div> <div>- DEAD END AND SUBDIVISION ROADS ARE NOT "THROUGH" ROADWAYS.</div> <div>- INSTALL 500' +/- FROM EACH -Y- LINE APPROACH AS SHOWN ABOVE.</div> <div>- FOR MULTIPLE -Y- LINES THAT ARE SEPARATED BY 0.25 MILES OR LESS, TREAT AS A SINGLE UNIT AND INSTALL WITHIN 500' OF EACH APPROACH.</div> <div>- A MAXIMUM OF 2 SIGN SETS PER MILE. DO NOT INSTALL WHEN -Y- LINES ARE WITHIN 0.5 MILES FROM "END ROAD WORK" SIGN.</div> <div>- FOR TEE INTERSECTIONS, INSTALL WITHIN 500' +/- OF THE INTERSECTION ALONG -L- LINE.</div>		 W20-1 48" X 48"	 W20-7 A 48" X 48"
	<div>5</div> <div> G20-2 A 48" X 24"</div>	PLACE 500' FOLLOWING THE END OF CONSTRUCTION LIMITS OR AS SHOWN WHEN WORK ENDS AT A 3-WAY TEE INTERSECTION.			
LESS 2 MILES	FOR RESURFACING MAPS WITH CONSTRUCTION LIMITS LESS THAN 2 MILES IN LENGTH, NO STATIONARY SIGNS ARE REQUIRED. USE PORTABLE "ROAD UNDER CONSTRUCTION" OR "ROAD WORK AHEAD" SIGNS IN LIEU OF STATIONARY ADVANCE WARNINGS SIGNS.				

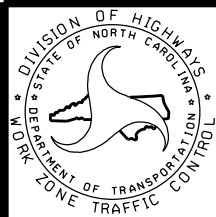

ADVANCE WARNING SIGNS  
FOR  
RURAL AND SUBURBAN  
2-LANE ROADWAY  
RESURFACING

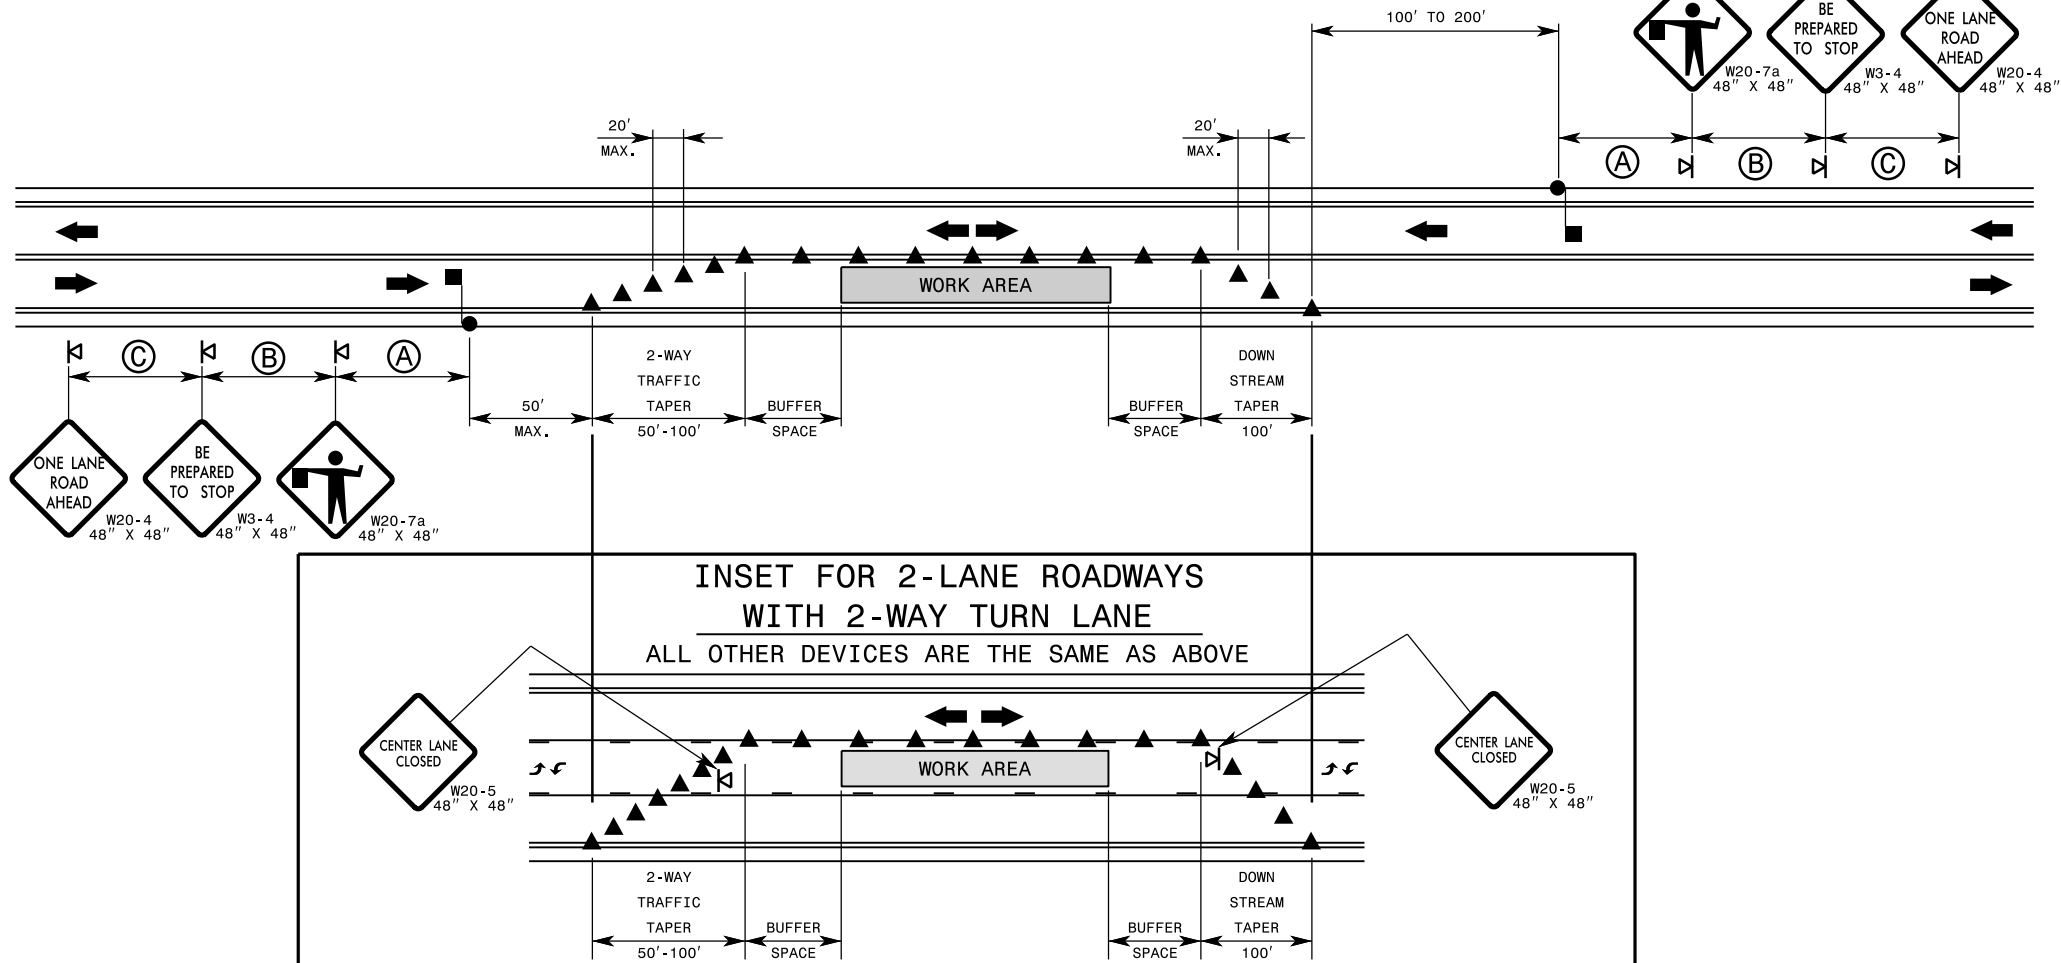

**GENERAL NOTES FOR FLAGGING OPERATIONS**

- 1- REFER TO RSD. 1101.11, SHEETS 1 & 4, FOR "L" DISTANCE AND SIGN SPACING.
- 2- INSTALL LANE CLOSURES WITH THE TRAFFIC FLOW, BEGINNING WITH DEVICES ON THE UPSTREAM SIDE OF TRAFFIC.
- 3- REMOVE LANE CLOSURES AGAINST THE TRAFFIC FLOW, BEGINNING WITH DEVICES ON THE DOWNSTREAM SIDE OF TRAFFIC.
- 4- FOR POSTED SPEED LIMITS BELOW 45 MPH, CHANNELIZING DEVICE SPACING SHALL BE 20 FEET IN THE TAPERS AND THE SHIFTS AND 40 FEET IN THE TANGENTS. FOR POSTED SPEED LIMITS GREATER THAN OR EQUAL TO 45 MPH, CHANNELIZING DEVICE SPACING SHALL BE 40 FEET IN THE TAPERS AND THE SHIFTS AND 80 FEET IN THE TANGENTS.
- 5- EXTEND LANE CLOSURES AT THE BUFFER SPACE SUCH THAT STOPPING SIGHT DISTANCE IS PROVIDED TO THE FLAGGER (REFER TO RSD. 1101.11, SHEET 2).
- 6- DO NOT STOP ALL DIRECTIONS OF TRAFFIC FOR MORE THAN 5 MINUTES AT A TIME.
- 7- DRUMS OR SKINNY DRUMS MAY BE USED IN LIEU OF CONES. REFER TO RSD. 1180.01 FOR SKINNY DRUM REQUIREMENTS.
- 8- USE FLAGGERS TO CONTROL TRAFFIC AT INTERSECTIONS AFFECTED BY THE LANE CLOSURE. SUPPLEMENT FLAGGERS LOCATED AT INTERSECTIONS WITH FLAGGER AHEAD SIGNS (W20-7A) PLACED APPROXIMATELY 250 FT. IN ADVANCE OF THE FLAGGER. FOR SIGNALIZED INTERSECTIONS PLACE SIGNALS IN THE FLASH MODE AND USE LAW ENFORCEMENT.
- 9- REFER TO THE CURRENT MUTCD FOR FLAGGER CONTROL, REQUIREMENTS, AND PROCEDURES.
- 10- DO NOT EXCEED A 1 MILE LANE CLOSURE LENGTH UNLESS OTHERWISE SHOWN IN THE TMP OR AS DIRECTED BY THE ENGINEER.

- 11- IF VEHICLE QUEUES WILL REACH WITHIN 100' OF EITHER SIDE OF ACTIVE RAILROAD TRACKS, PROVIDE A UNIFORMED LAW ENFORCEMENT OFFICER OR FLAGGER TO PREVENT VEHICLES FROM STOPPING WITHIN THE GRADE CROSSING. PROVIDE OFFICER OR FLAGGER EVEN IF AUTOMATIC WARNING MEASURES ALREADY EXIST.
- 12- THIS DETAIL IS APPLICABLE FOR OPERATIONS IN PLACE FOR 72 HOURS OR LESS. FOR LONGER DURATION OPERATIONS, SIGNING AND PAVEMENT MARKINGS MAY NEED TO BE ALTERED.

**GENERAL NOTES FOR PILOT CAR OPERATIONS**

- 1- USE PILOT CARS WHEN DIRECTED BY THE ENGINEER.
- 2- IF ROADWAY WIDTH IS LESS THAN 22 FEET (EOP TO EOP), CONES MAY NOT BE REQUIRED ALONG WORK AREA, AND AT THE DISCRETION OF THE ENGINEER, CONES MAY BE OMITTED ALONG THE WORK AREA IF USING A PILOT CAR.
- 3- CONES ARE ALWAYS REQUIRED IN THE UPSTREAM AND DOWNSTREAM TAPERS.
- 4- MOUNT SIGN G20-4 "PILOT CAR FOLLOW ME" AT A CONSPICUOUS POSITION ON THE REAR OF THE PILOT VEHICLE.
- 5- UNLESS APPROVED BY THE ENGINEER, DO NOT INSTALL MORE THAN ONE (1) MILE OF LANE CLOSURE, MEASURED FROM THE BEGINNING OF THE MERGE TAPER TO THE END OF THE LANE CLOSURE.
- 6- ADVISE RESIDENTS AND BUSINESSES WITHIN THE LANE CLOSURE LIMITS ABOUT METHODS OF SAFE EGRESS AND INGRESS FROM DRIVEWAYS DURING FLAGGING AND PILOT CAR OPERATIONS.

**LEGEND**

FLAGGER

CONE

PORTABLE SIGN

DIRECTION OF TRAFFIC FLOW





